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TOTAL		27						

CHESTERFIELD COUNTY

PROPOSED PLANS
FOR

CHESTERFIELD COUNTY RICK HENRY ROAD FROM: SC RTE. 151 TO: TERMINI

RICK HENRY ROAD

FROM STA. 10+00.00 TO STA. 38+32.56

ENVIRONMENTAL PERMIT INFORMATION									
USACE PERMIT	YES	_X_NO							
NEPA DOCUMENT	YES	_X_NO							
401 CERTIFICATION	YES	_X_NO							
OCRM CAP	YES	_X_NO							
NAVIGABLE WATERSSC	USCG	USACE	_X_N/A						


3 DAYS BEFORE DIGGING IN SOUTH CAROLINA

CALL 811

SOUTH CAROLINA 811 (SC811)
WWW.SC811.COM
ALL UTILITIES MAY NOT BE A MEMBER OF SC811

RAILROAD INVOLVEMENT? YES / NO

Т	RAFFIC DATA	
NA	ADT	
	ADT	
	TRUCKS	

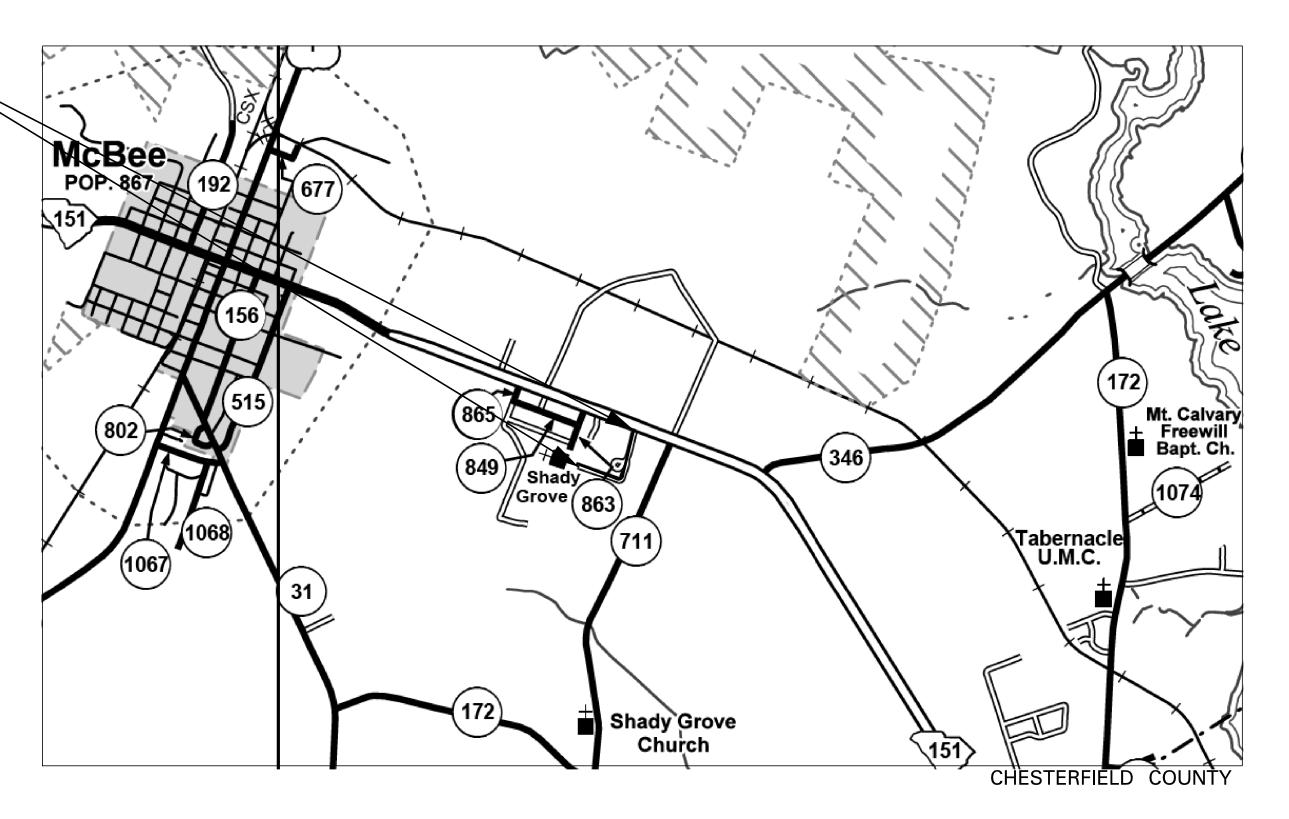

LAYOUT


SCALE 1 INCH = 1320 FEET

NET LENGTH OF ROADWAY 0.536	MILES
NET LENGTH OF BRIDGES	MILES
NET LENGTH OF PROJECT 0.536	MILES
LENGTH OF EXCEPTIONS	MILES
GROSS LENGTH OF PROJECT 0.536	MILES

EQUALITIES IN STATIONING

NONE

NOTE: EXCEPT AS MAY OTHERWISE BE SPECIFIED ON THE PLANS OR IN THE SPECIAL PROVISIONS, ALL MATERIALS AND WORKMANSHIP ON THIS PROJECT SHALL CONFORM TO THE SOUTH CAROLINA DEPARTMENT OF TRANSPORTATION STANDARD SPECIFICATIONS FOR HIGHWAY CONSTRUCTION (2007 EDITION) AND THE STANDARD DRAWINGS FOR ROAD CONSTRUCTION IN EFFECT AT THE TIME OF LETTING.

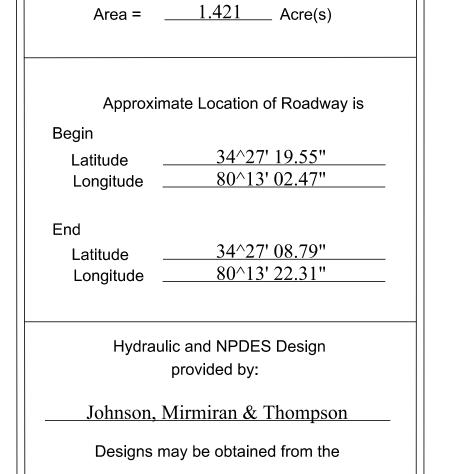


NPDES PERMIT INFORMATION


NPDES Disturbed

Hydraulic Design Reference for these plans is the:

2009

Edition of SCDOT's "Requirements for Hydraulic Design Studies"

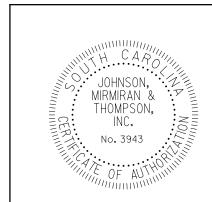

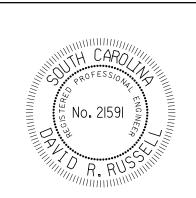





FED. RD. DIV. NO.	STATE	COUNTY	PROJECT ID	NO.	SHEET NO.	
3	S.C.	CHESTERFIELD	21-04464-001		2	

Rick Henry Road

CHESTERFIELD COUNTY
SUMMARY OF ESTIMATED QUANTITIES

ITEM NO.	PAY ITEM	QUANTITY	PAY UNIT			

ITEM NO.	PAY ITEM	QUANTITY	PAY UNIT
1021000	MODII IZATIONI	1.000	L.S.
1031000 1071000	MOBILIZATION TRAFFIC CONTROL	1.000	L.S.
2011000	CLEARING AND GRUBBING WITHIN RIGHT OF WAY	1.000	L.S.
2031000	UNCLASSIFIED EXCAVATION	1394.000	CY
2033000	BORROW EXCAVATION	3716.000	CY
3051200	MACADAM BASE COURSE (6" UNIFORM)	7070.000	SY
3063306	CEMENT MODIFIED RECYCLED BASE (6" UNIFORM)	7070.000	SY
3069900	MAINTENANCE STONE	100.000	TON
4010005	PRIME COAT	1909.000	GAL. TON
4030340 4037220	HOT MIX ASPHALT SURFACE COURSE TYPE C DRIVEWAY PAVING -SURFACE TYPE C	600.000 40.000	TON
6021120	PERMANENT CONSTRUCTION SIGNS (GROUND MOUNTED)	96.000	SF
6250025	24" WH SLD.LINE-PVT.EDGE-F.D.PNT	30.000	LF
6271005	4" WHITE BROKEN LINES(GAPS EXCL.)THERMOPLASTIC- 90 MIL.	100.000	LF
6510105	FLAT SHEET TYPE III, FIXED SIZE	18.000	SF
6531210	U-SEC. POST FOR SIGN SUPP. 3P	24.000	LF
7141112	15" RC PIPE CULCLASS III	232.000	LF
7141113	18" RC PIPE CULCLASS III	88.000	LF
7141114	24" RC PIPE CULCLASS III	40.000	LF
8041010 8041020	RIPRAP CLASS "A" FOR DITCH CHECKS	60.000	TON
8041020	RIPRAP CLASS "B" GEO/TEX. FOR EROSION CONTROL UNDER RIPRAP (CLASS 2)	16.000 32.000	SY
8100001	PERMANENT VEGATATION	6.878	MSY
8103100	TEMPORARY VEGATATION	3.439	MSY
8151110	TEMP. EROSION CONTROL BLANKET	307.000	SY
8152007	SEDIMENT TUBES FOR DITCH CHECKS	460.000	LF
8153000	SILT FENCE	5670.000	LF
8153090	REPLACE/REPAIR SILT FENCE	567.000	LF
8154050 8156490	REM./SILT RETAIN BY SILT FENCE STABILIZED CONSTRUCTION ENTRANCE	1416.000 550.000	LF SY
	†		

JOHNSON,

JOHNSON,

MIRMIRAN &

THOMPSON,

INC.


No. 3943





D. RD. STATE COUNTY PROJECT ID ROAD/ROUTE SHEET NO. 3 S.C. CHESTERRFIELD 21-04464-001 3

TYPICAL SECTION OF IMPROVEMENT CHESTERFIELD COUNTY

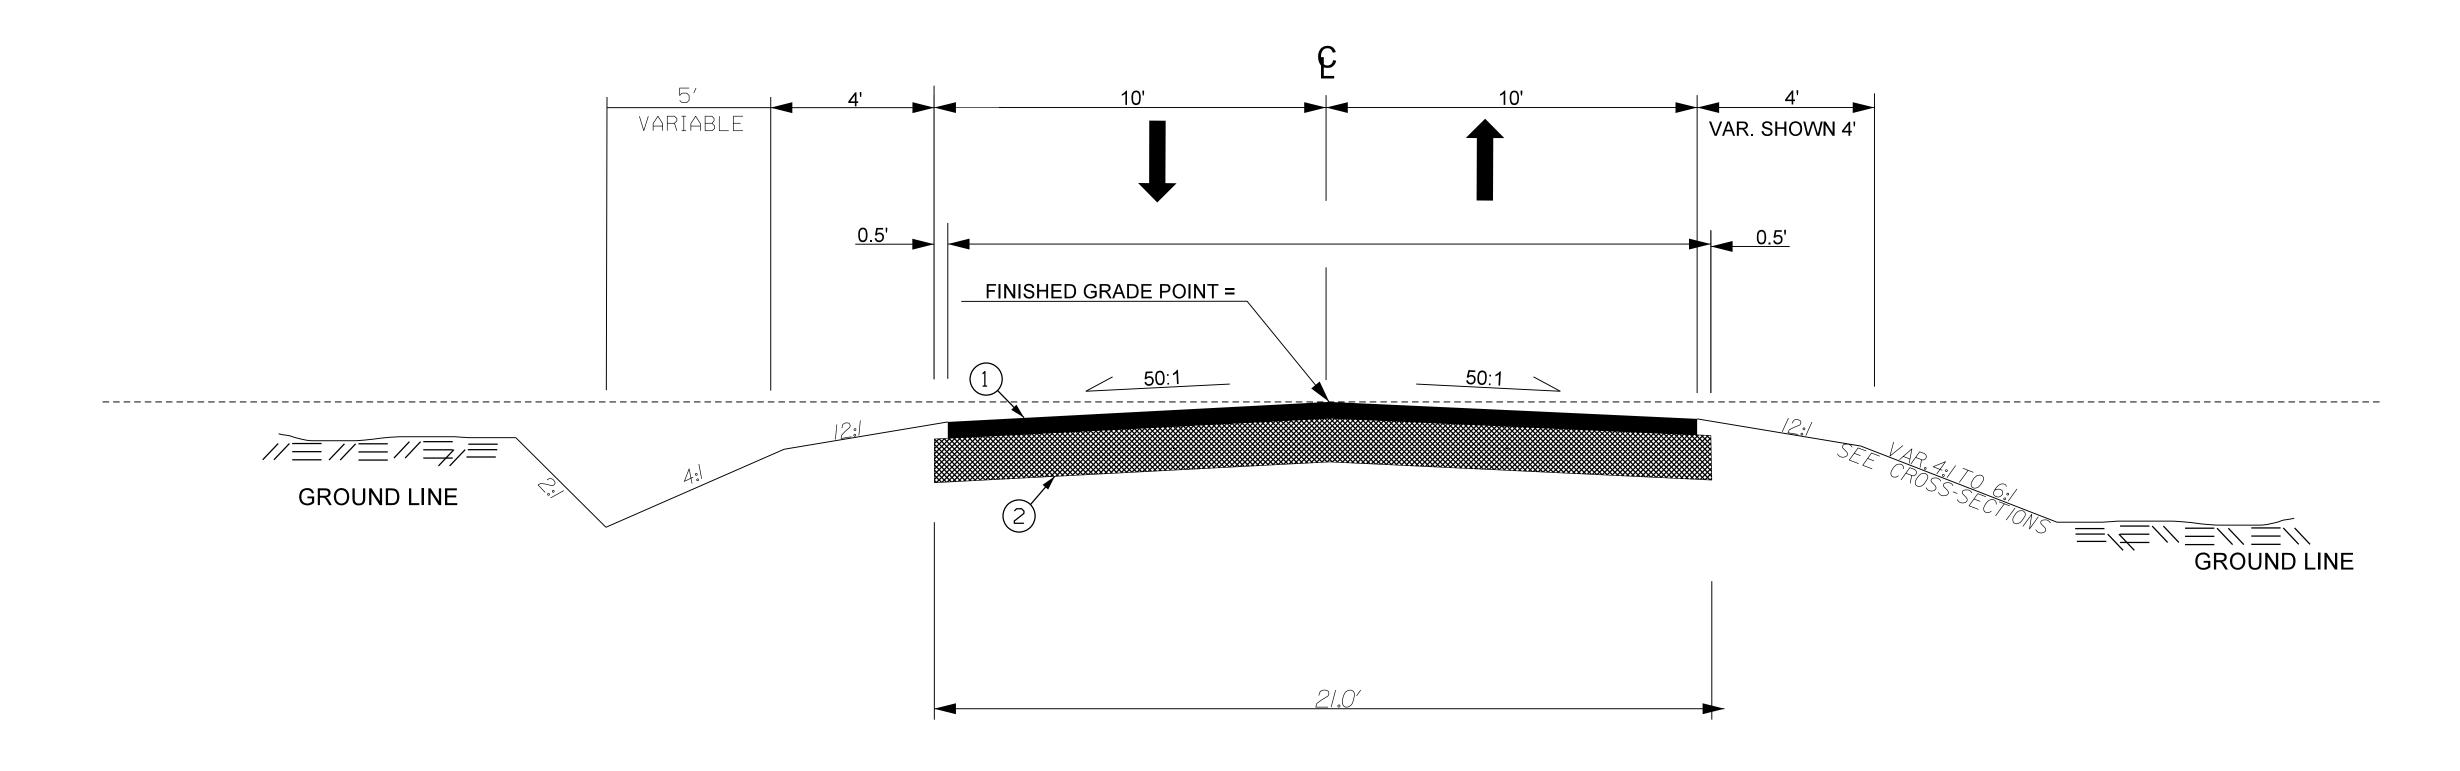

USE THIS SECTION ON RICK HENRY ROAD

STA. 10+00.00 TO STA. 38+32.56

- 1) HOT MIX ASPHALT SURFACE COURSE TYPE C 175 PSY
- *ALT.NO.1 CEMENT MODIFIED RECYLCED BASE (6" UNIFORM)


 ALT.NO.2 MACADAM BASE (6" UNIFORM)

*NOTE: IF CEMENT MODIFIED RECYLCED BASE IS USED ADD A LEVELING LIFT OF ASPHALT SURFACE COURSE TYPE E @ 45 PSY

 NOTE: SOME SHOULDER MAINTENANCE MAY BE REQUIRED

USE EXCESS "FLUFF" MATERIAL FOR DRIVEWAYS AND SHOULDERS.

Road group designation for this FAS Rural Route or State "C" Road per EDM PC-3 is Group 1

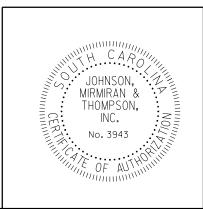





RICK HENR'	Y RD. DESIG	N SPEED	
MPH	FROM STA.	TO STA.	
3Ø	10+00.00	38+32.56	
EXCEPTIC	NS TO DESIGN SP	EED	

ROAD DESIGN CHESTERFIELD COUNTY

TYPICAL SECTION

SCALE 1"V=NTS SCALE 1"H=NTS RTE./RD.

RICK HENRY ROAD

CHESTERFIELD COUNTY RIGHT-OF-WAY DATA SHEET

TRACT		TAX MAP REFERENCE			C	A BTAIN		REMAINDER	REMAINDER			OUTFALL DITCH		DRAINAGE	EROSION	ENTRANCE	
NO.			TOTAL TRACT ACRES	OUTFALL DITCH ACRES	LEFT	RIGHT	TOTAL	LEFT B ACRES	RIGHT B ACRES	DATE ACQUIRED	TYPE OF INSTRUMENT	OUTFALL DITCH PERMISSION (YES)	SLOPE PERMISSION (YES)	STRUCTURE	EROSION CONTROL PERMISSION (YES)	CONSTRUCTION PERMISSION (YES)	REMARKS
/ F	ICJ INC.	122-000-000-060															
	IANCY ALDRICH HENRY & AMES RICHARD HENRY	122-000-000-056															
	LARA B.PETTUS IFE ESTATE	/22-000-000-059															
	LEATUS PETTUS JR.	122-000-000-108															
	LMOND FOREST PRODUCTS INC.	122-000-000-128															
	LEATUS PETTUS JR.	122-000-000-108															
7	NDREW HARPER JR.	122-000-000-127															
	LPHONSO MURPHY & ATTIE MURPHY	122-000-000-109															
l-	ELEN M.JOHNSON & ARA M.JOHNSON	122-000-000-126															
10 JI	MMY PETTUS,ETAL	122-000-000-110															
// J.	ARRETT WILLIAMS	122-000-000-125															
12 G	LORIA GODINEZ & OMINGUEZ GODINEZ	122-000-000-111															
17	ONNIE BRISTER	122-000-000-124															
14	NTONIO W.BRISTER	122-000-000-112															
15 _F	LORENCE V.BRISTER	122-000-000-123															
16 A	NDRIA HUNTER & BORIS HUNTER	122-000-000-113															
17 N	'ILLIE MAE PRICE	122-000-000-114															
18 G	ARY HODNETT & EBORAH HODNETT	122-000-000-122	9														
	GARY HODNETT & DEBORAH HODNETT	122-000-000-121															
	AMES W.BRISTER & DANNE AUSTIN BRISTER	122-000-000-115															
21 N	ED ROGERS JR.	122-000-000-116															
22	ARTIN PALACIOS	122-000-000-120	,														
23 _F	ICJ INC.	122-000-000-119															
24 A	DAN N.MENDOZA	122-000-000-118															
25 _A	'ED ROGERS JR.	122-000-000-117															

NOTES:

TOTAL OBTAIN INCLUDES HIGHLAND, MARSH AND OUTFALL DITCHES. OBTAINS WILL BE SHOWN IN SQUARE
FEET AND ACRES. ACRES WILL BE SHOWN
IN PARENTHESES UNDER SQUARE FEET. IN
RURAL AREAS OBTAINS MAY BE SHOWN IN
ACRES ONLY. OUTFALL DITCHES WILL BE
SHOWN IN ACRES ONLY.


SHOW REMAINDER IN SQUARE FEET WHEN LESS THAN 0.25 ACRE.

KEVI310N3							
DATE	TRACT NO.	REMARKS	DATE	TRACT NO.	REMARKS		

 FED. RD. DIV. NO.
 STATE
 COUNTY
 PROJECT ID
 NO.
 SHEET NO.

 3
 S.C.
 CHESTERFIELD
 21-04464-001
 4A

RICK HENRY ROAD

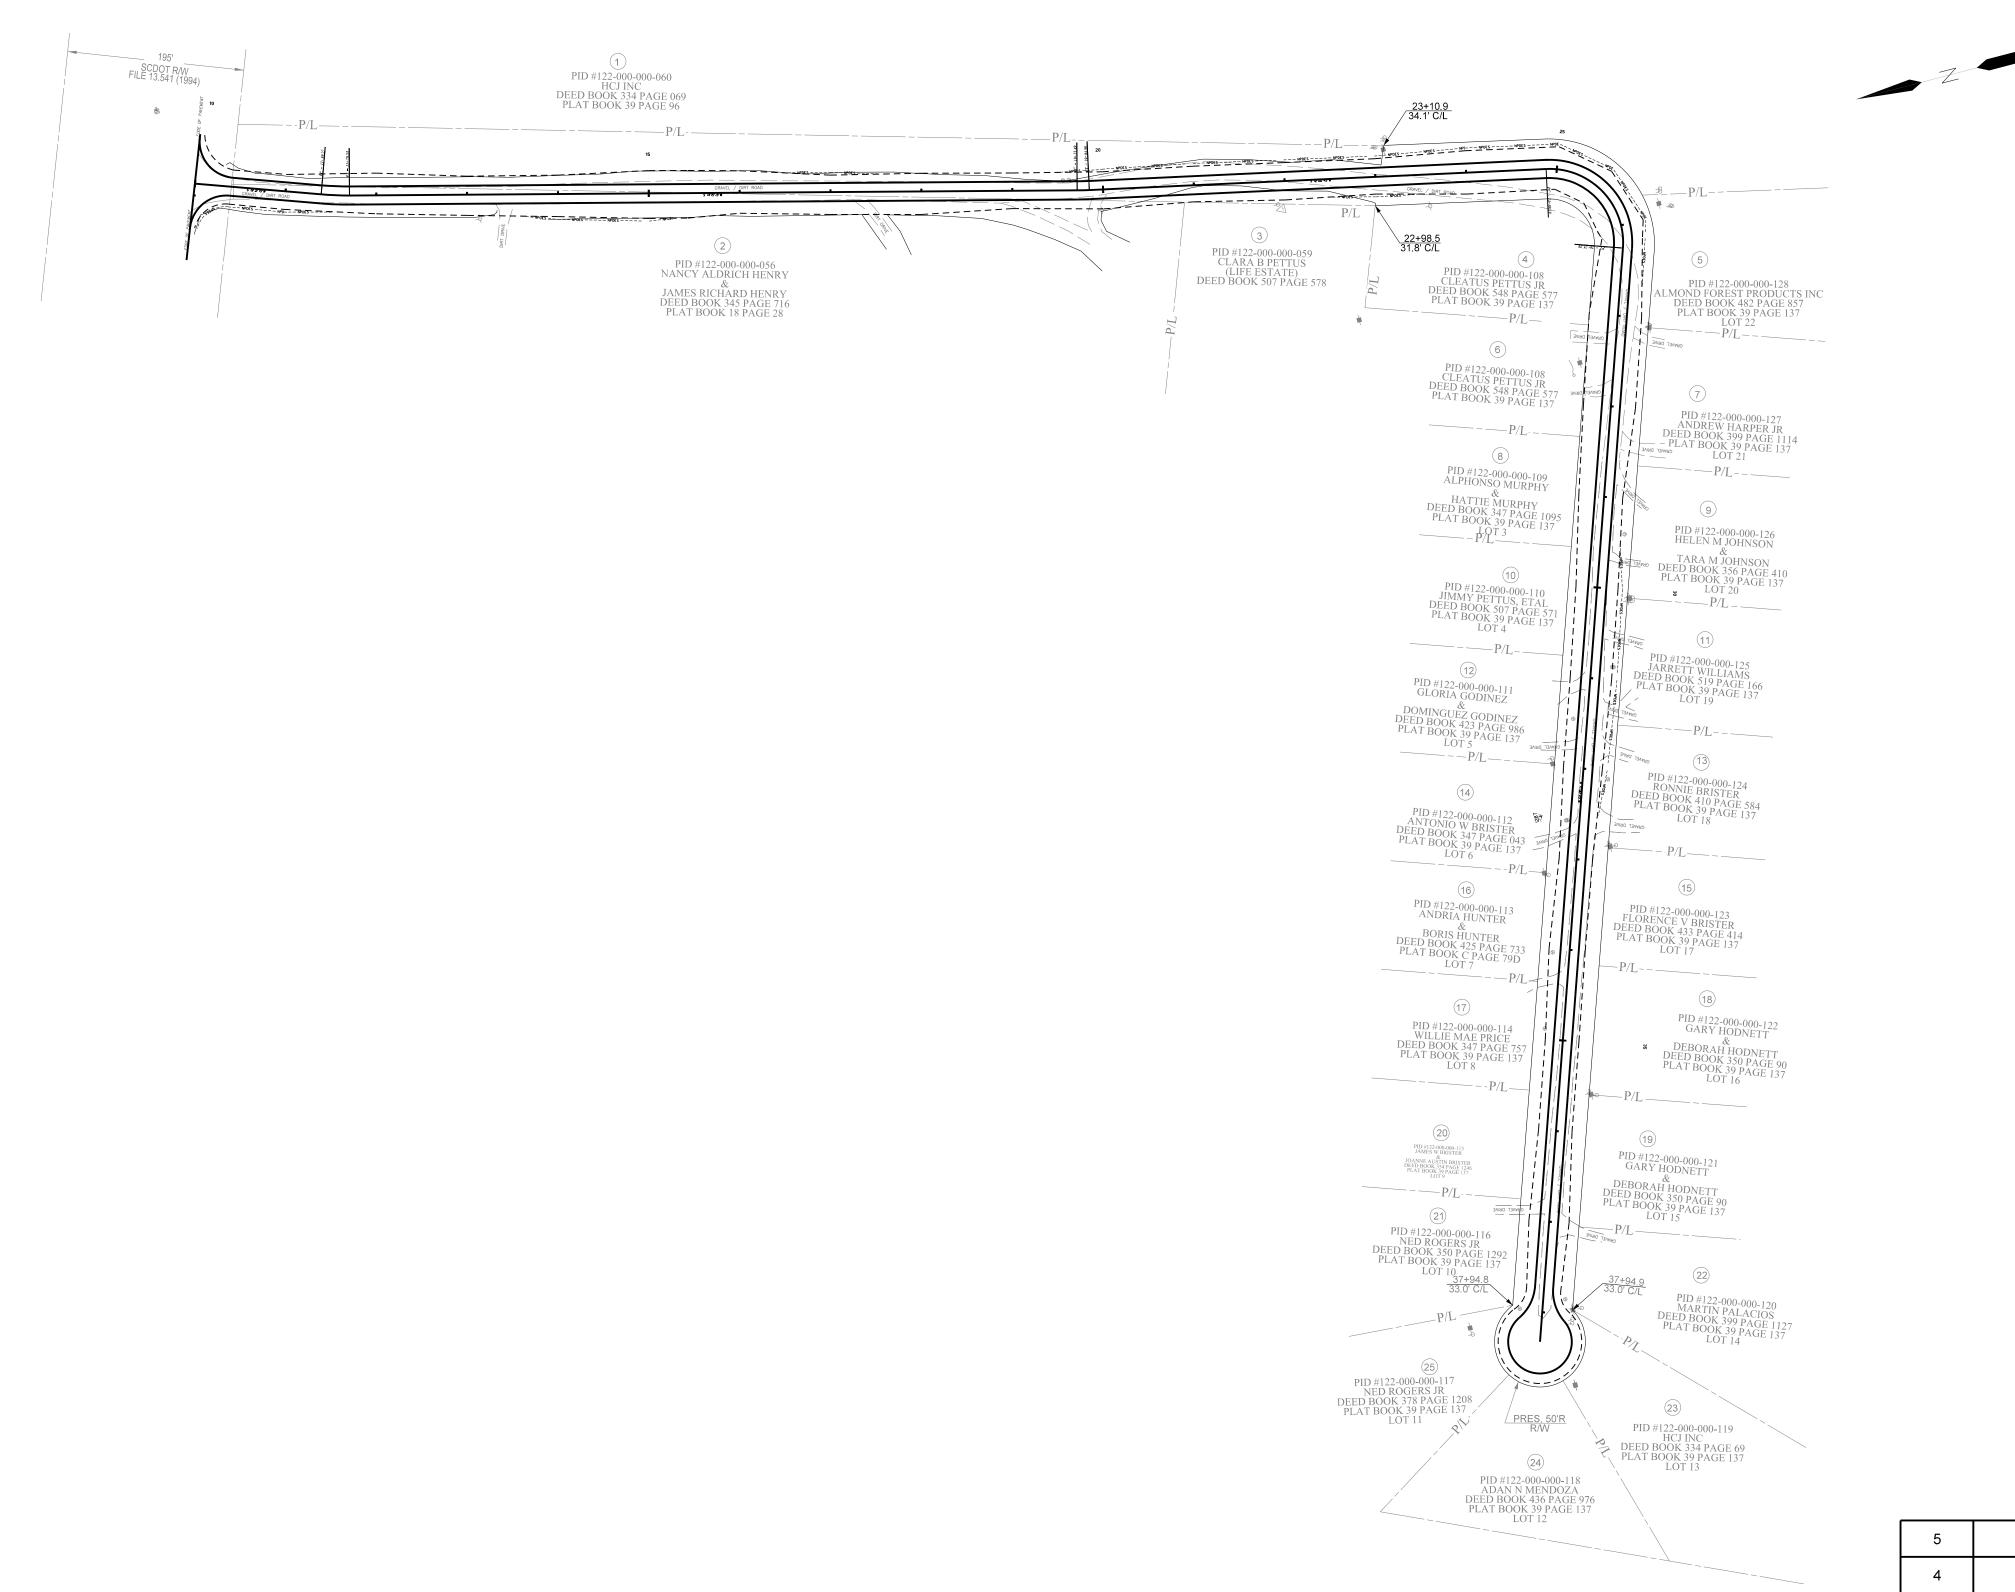

5				CHESTERFIELD COUNTY
4				CHESTERFIELD COUNTY
3				
2				PROPERTY STRIP MAP
1				
REV. NO.	BY	DATE	DESCRIPTION OF REVISION	SCALE 1" = 100'

Rich Henry Road

Chain RICK_HENRY contains: 14 CUR RICK_HENRY1 CUR RICK_HENRY2 CUR RICK_HENRY3 15

Beginning chain RICK_HENRY description

N 954,914.0217 E 2,235,919.1868 Sta 10+00.00

Course from 14 to PC RICK_HENRY1 S 19° 31' 14.60" W Dist 139.2745

Curve Data

Curve RICK_HENRY1

11+54.91 N 954,768.0129 E 2,235,867.4229

Delta = $5^{\circ} 16' 01.36'' (LT)$

Degree = 16° 51' 06.12" 15.6386

Tangent = 31.2553 Length =

340.0000 Radius =

0.3595 External =

31.2443 Long Chord =

Mid. Ord. = 0.3591 11+39.27 N 954,782.7526 E 2,235,872.6485 P.C. Station

P.T Station 11+70.53 N 954,752.8557 E 2,235,863.5724 C.C. N 954,669.1424 E 2,236,193.1056

Back = S 19° 31' 14.60" W

Ahead = S 14° 15' 13.24" W

Chord Bear = S 16° 53' 13.92" W

Course from PT RICK_HENRY1 to PC RICK_HENRY2 S 14° 15' 13.24" W Dist 800.9645

Curve Data

Curve RICK HENRY2

P.I. Station 19+78.15 N 953,970.1015 E 2,235,664.7248

Delta = 2° 14' 30.01" (LT) Degree = 16° 51' 06.12"

6.6520 Tangent =

13.3023 Length =

Radius = 340.0000

External = 0.0651

Long Chord = 13.3015 0.0651

Mid. Ord. = P.C. Station

19+71.49 N 953,976.5488 E 2,235,666.3626 P.T. Station 19+84.80 N 953,963.5952 E 2,235,663.3404

C.C. N 953,892.8355 E 2,235,995.8957

Back = S 14° 15' 13.24" W

Ahead = S 12° 00' 43.23" W

Chord Bear = S 13° 07' 58.23" W

Course from PT RICK_HENRY2 to PC RICK_HENRY3 S 12° 00' 43.23" W Dist 503.3933

Curve Data

Curve RICK_HENRY3

25+79.71 N 953,381.7047 E 2,235,539.5282 P.I. Station

Delta = 96° 58' 52.19" (RT)

Degree = 70° 44' 07.91"

91.5235 Tangent =

137.1039 Length = Radius = 81.0000

41.2193 External =

121.3132 Long Chord =

Mid. Ord. = 27.3178

P.C. Station 24+88.19 N 953,471.2242 E 2,235,558.5758

P.T. Station 26+25.29 N 953,411.4915 E 2,235,452.9875 N 953,488.0817 E 2,235,479.3494

Back = S 12° 00' 43.23" W

Ahead = N 71° 00' 24.58" W

Chord Bear = S 60° 30' 09.32" W

Course from PT RICK_HENRY3 to 15 N 71° 00' 24.58" W Dist 1,207.2696

N 953,804.4040 E 2,234,311.4448 Sta 38+32.56

Ending chain RICK_HENRY description

RICK HENRY Survey Control List

SURVEY GROUP:

ROAD/ROUTE: RICK HENRY

PIN / PRJ ID: 21-04464-001

CHARGE CODE:

COUNTY: CHESTERFIELD

	NORTHING	EASTING	ELEV	DESC
1	953793.653	2234322.537	387.053	PSC
2	953654.4730	2234769.3970	395.87	PSC
3	953393.5630	2235439.5560	395.23	PSC
4	953896.9090	2235677.7800	402.64	PSC
5	954422.9960	2235763.0320	399.76	PSC
6	954890.3440	2235950.7840	410.08	PSC


CURVE DATA

P.I. = 11 + 54.91 $\Delta = 5^{16} 01'' (LT)$ $D = 16^{51} 06''$ T = 15.64'L = 31.26'E = 0.36'R = 340.00'D.S. = 30 MPHeMAX = 0.060e = 0.41P.C. - LG% = 0.50

P.T. - LG% = 0.50

P.I. = 19 + 78.15 $\Delta = 2^{\wedge} 14' 30'' (LT)$ $D = 16^{\circ} 51' 06''$ T = 6.65'L = 13.30'E = 0.07'R = 340.00'D.S. = 30 MPHeMAX = 0.060e = 0.39P.C. - LG% = 0.50P.T. - LG% = 0.50

P.I. = 25 + 79.71 $\Delta = 96^{58'} 52'' (RT)$ $D = 70^{44} 08''$ T = 91.52'L = 137.10'E = 41.22'R = 81.00'D.S. = 30 MPHeMAX = 0.060e = 0.60P.C. - LG% = 0.50P.T. - LG% = 0.50

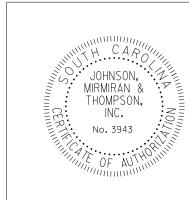









CHESTERFIELD COUNTY


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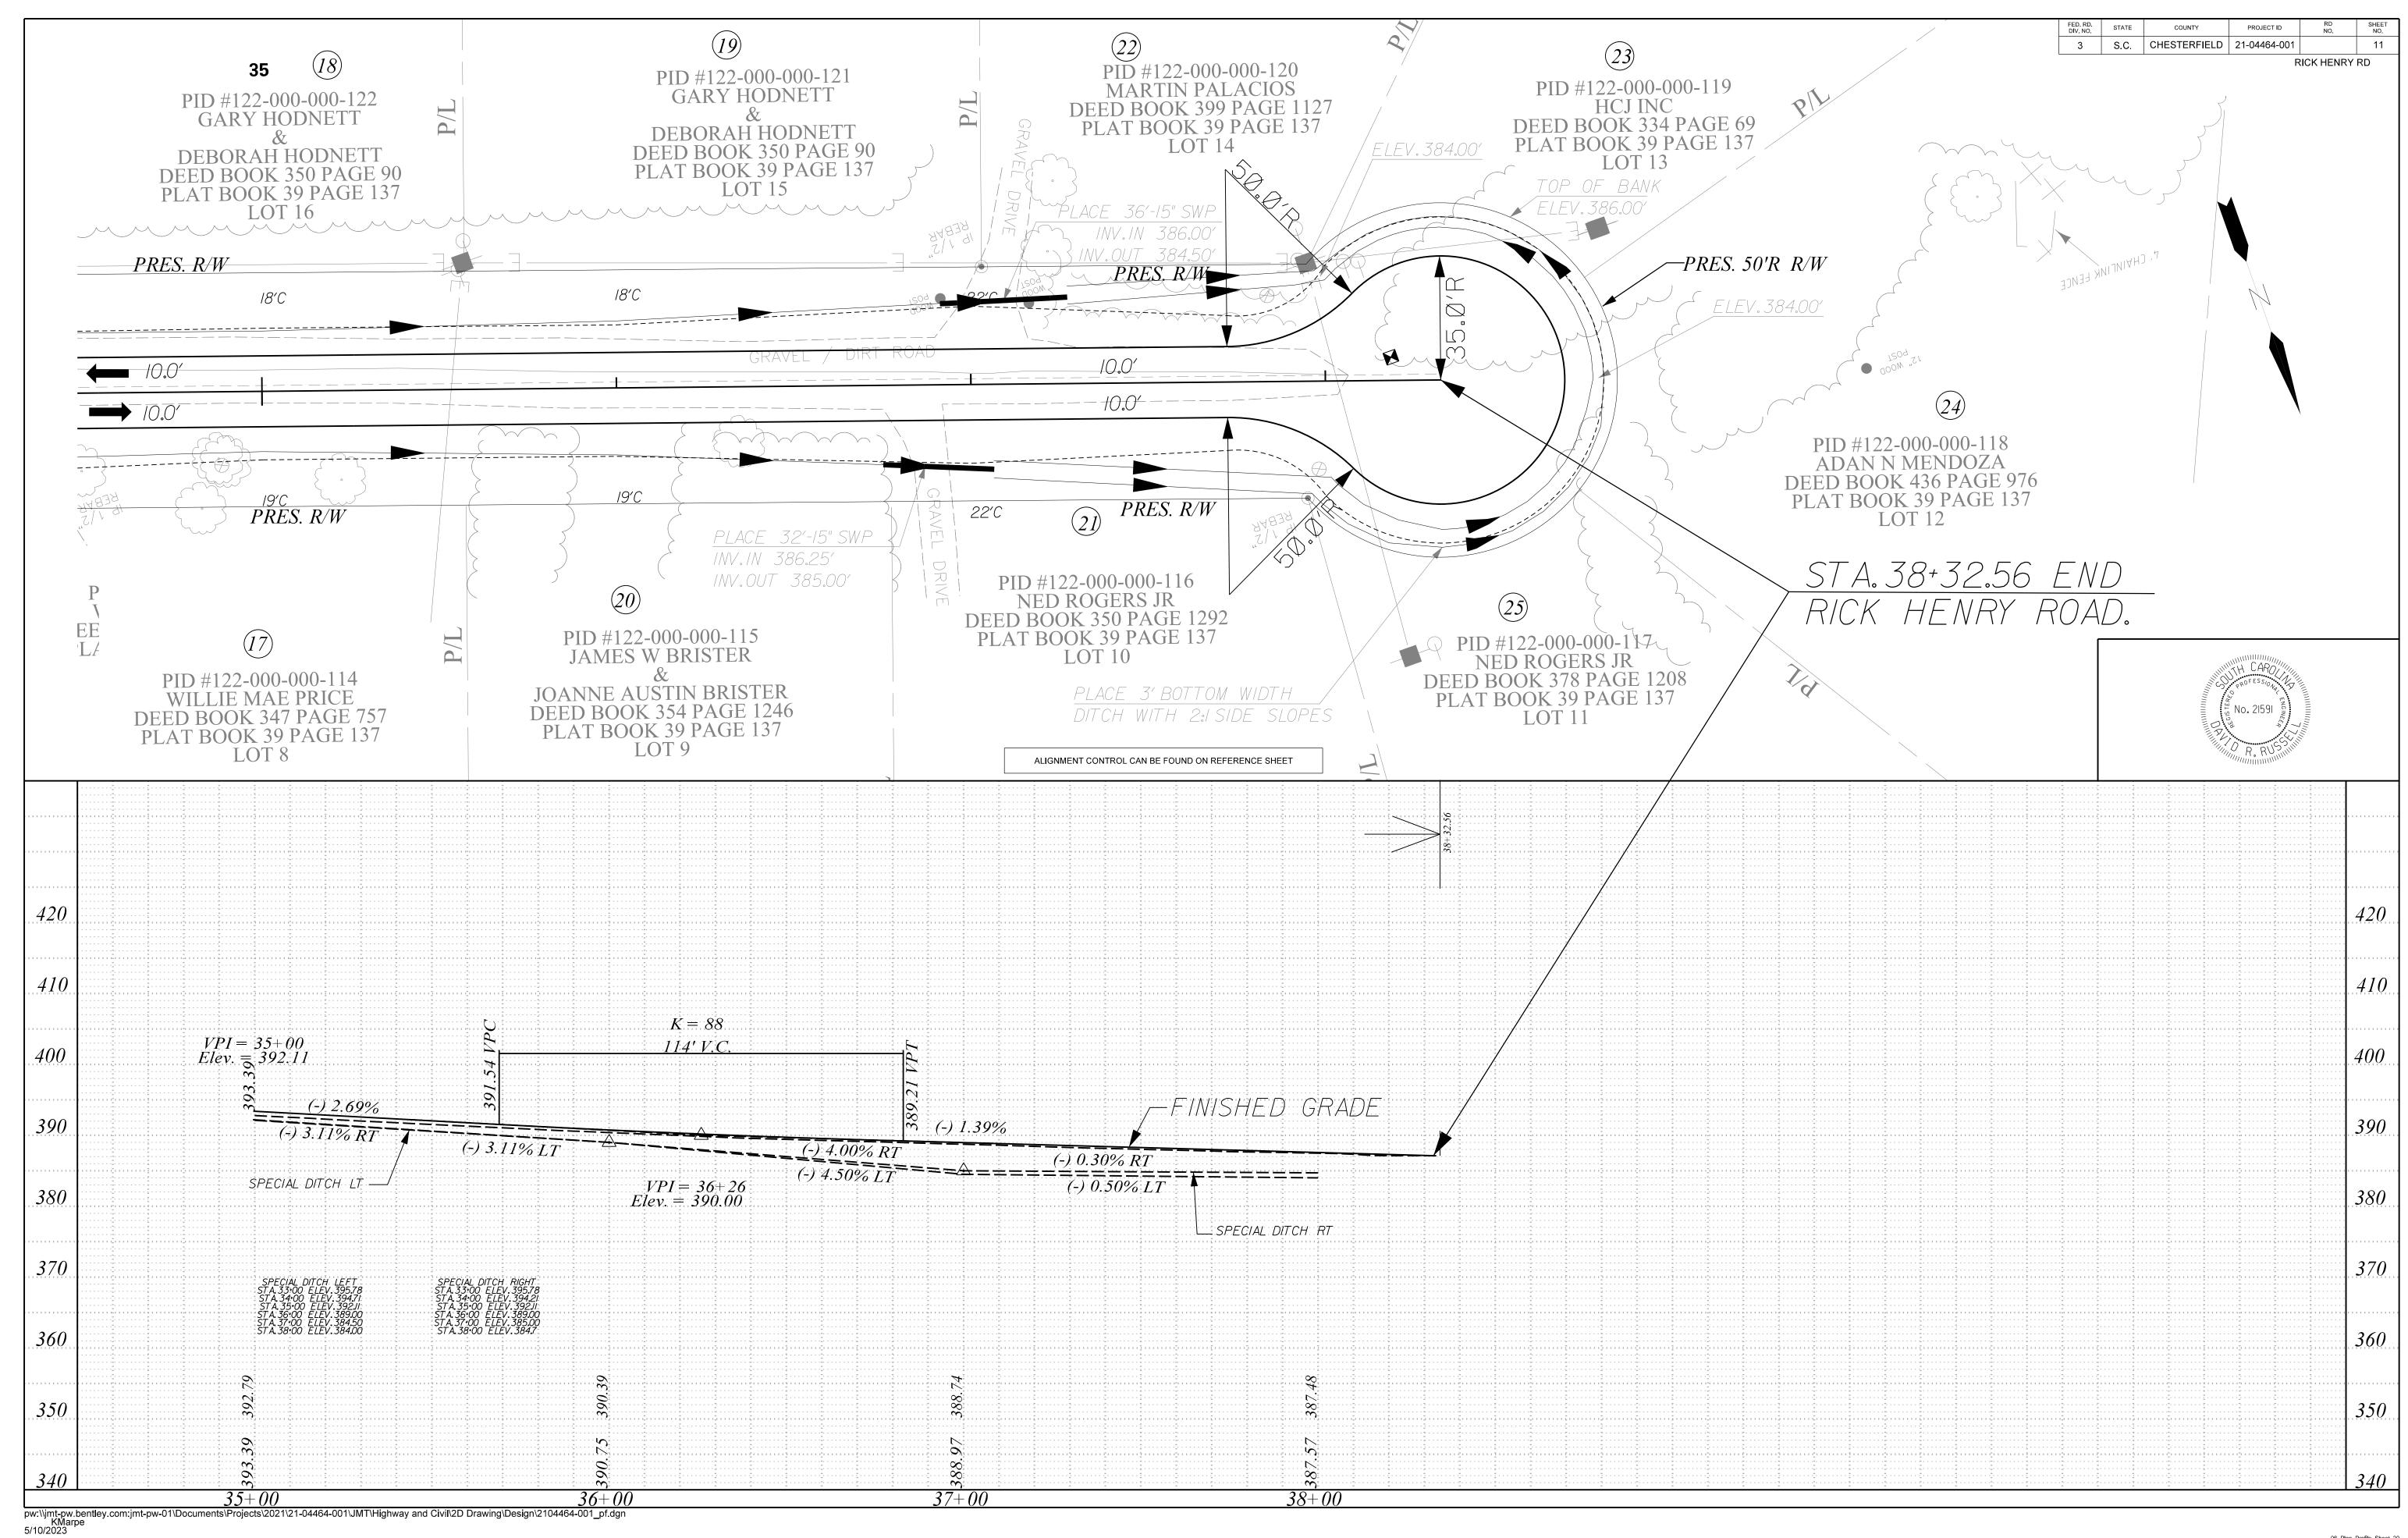


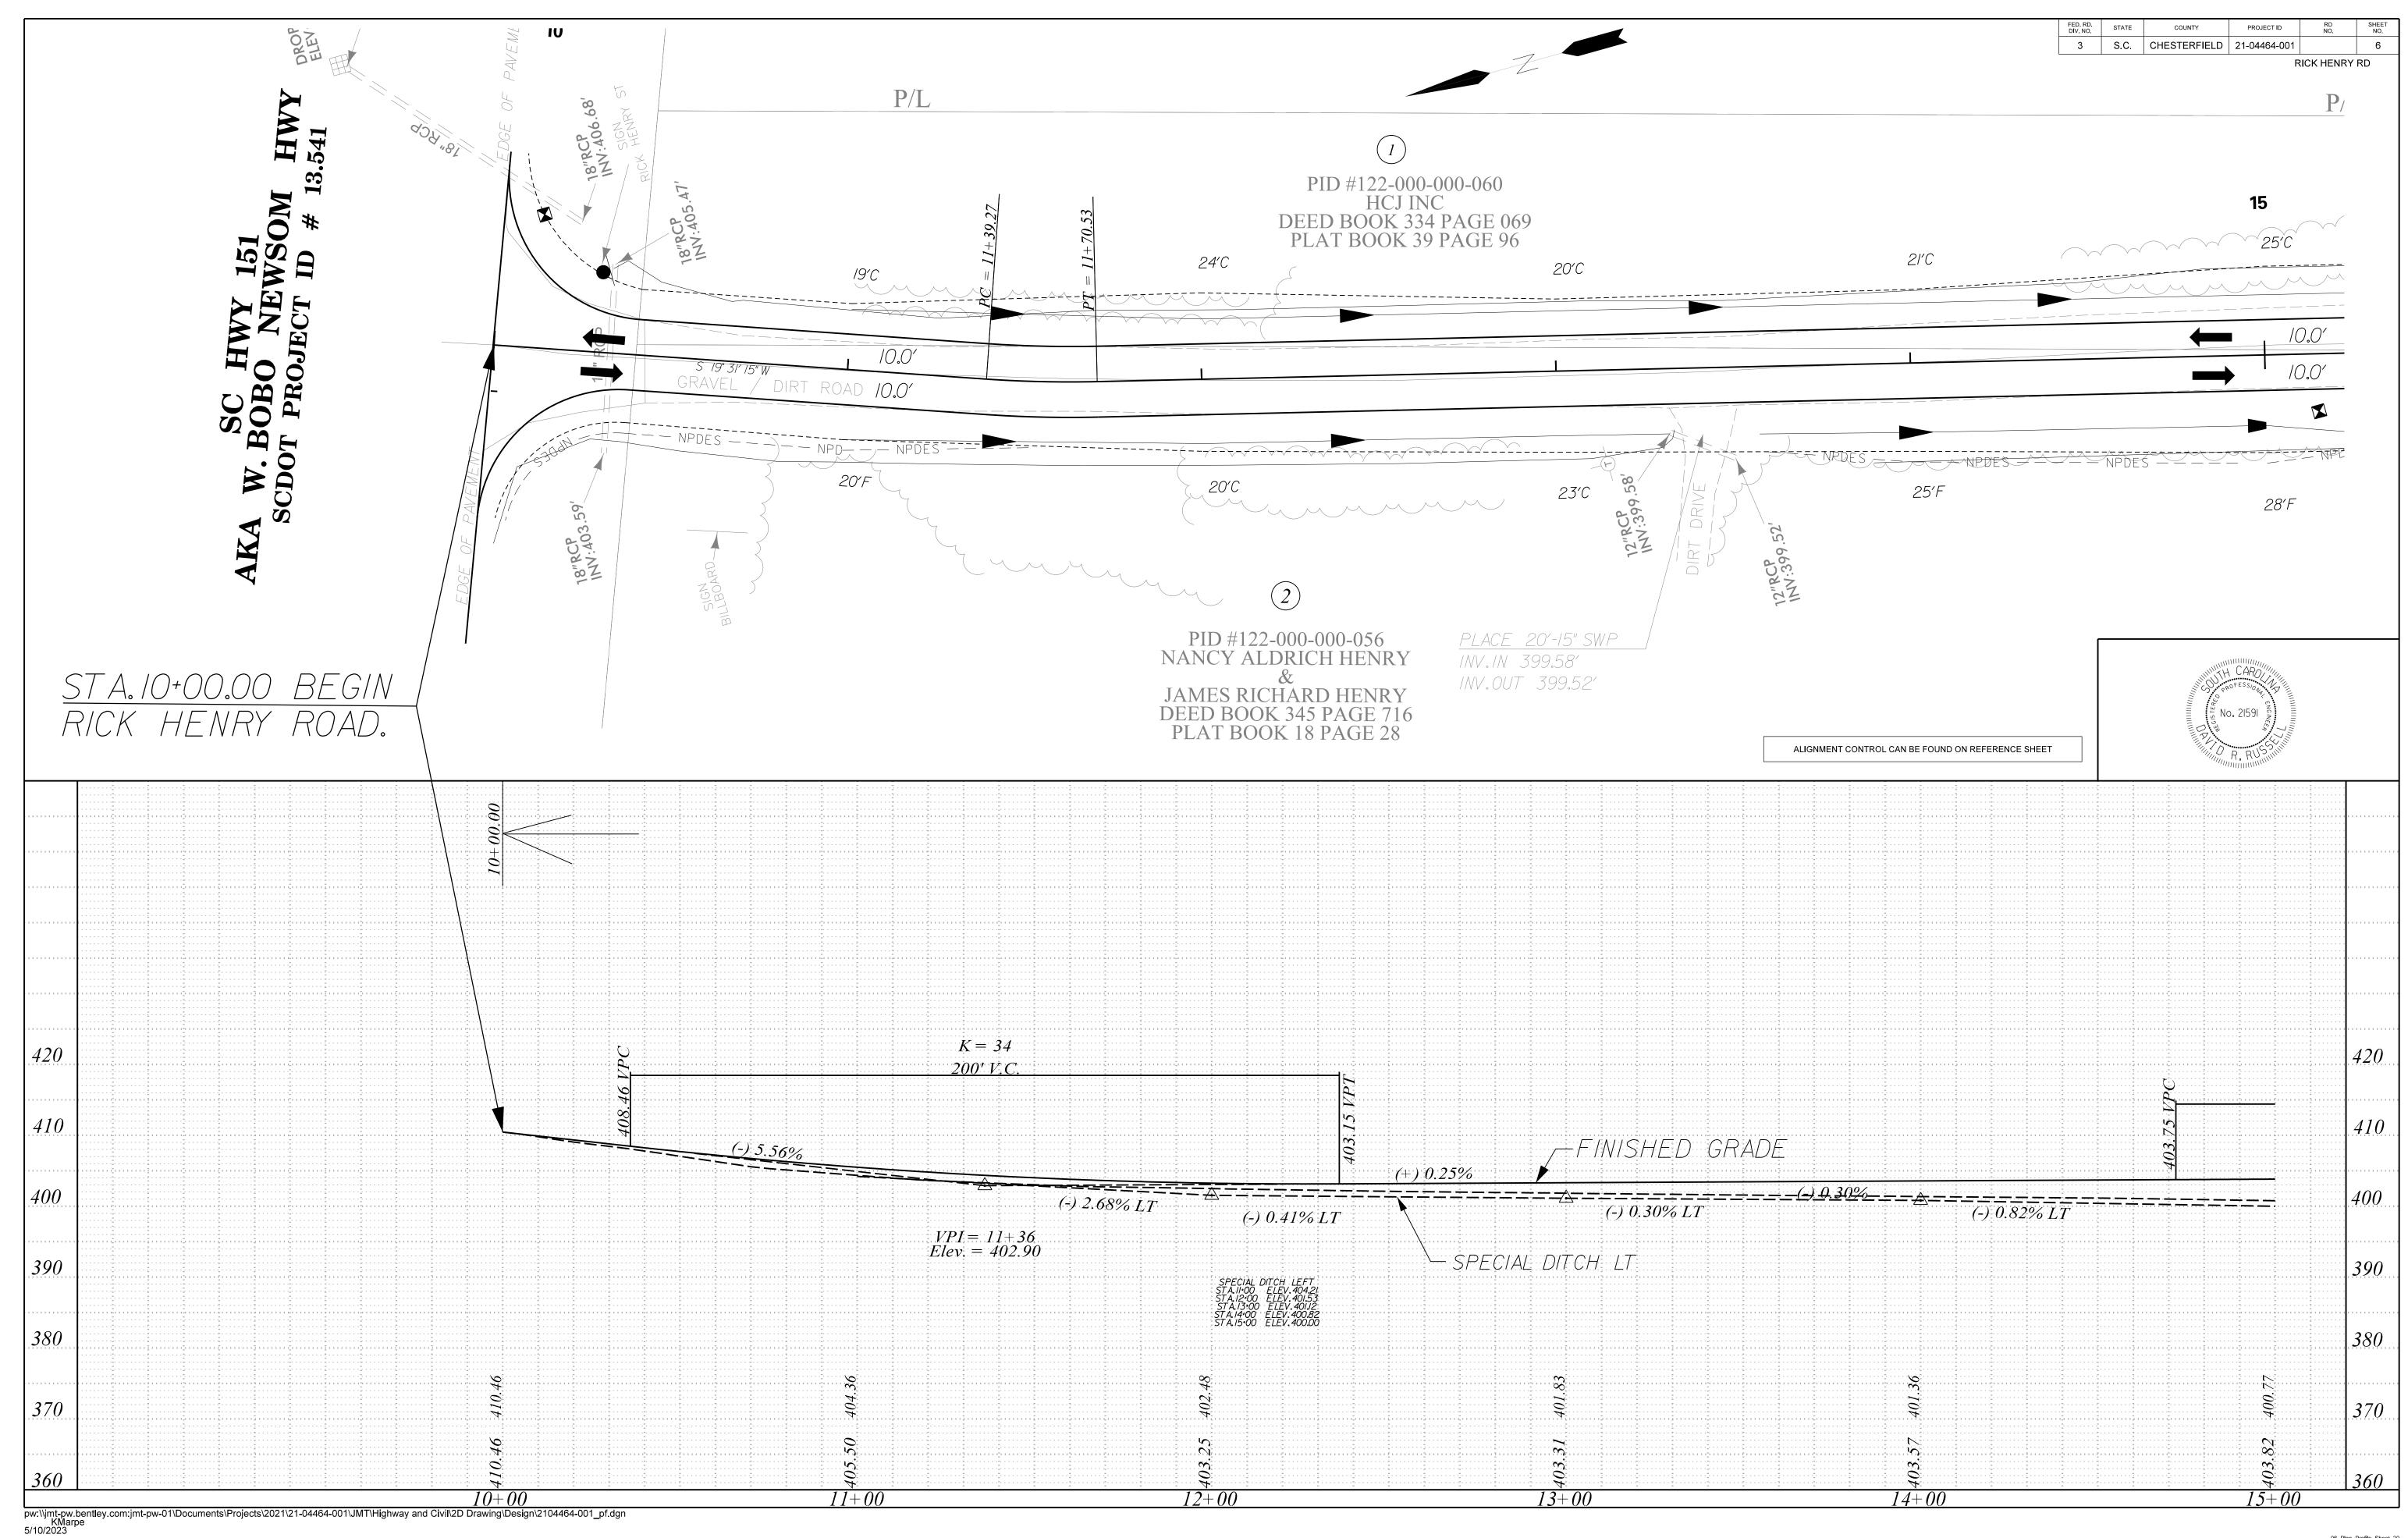

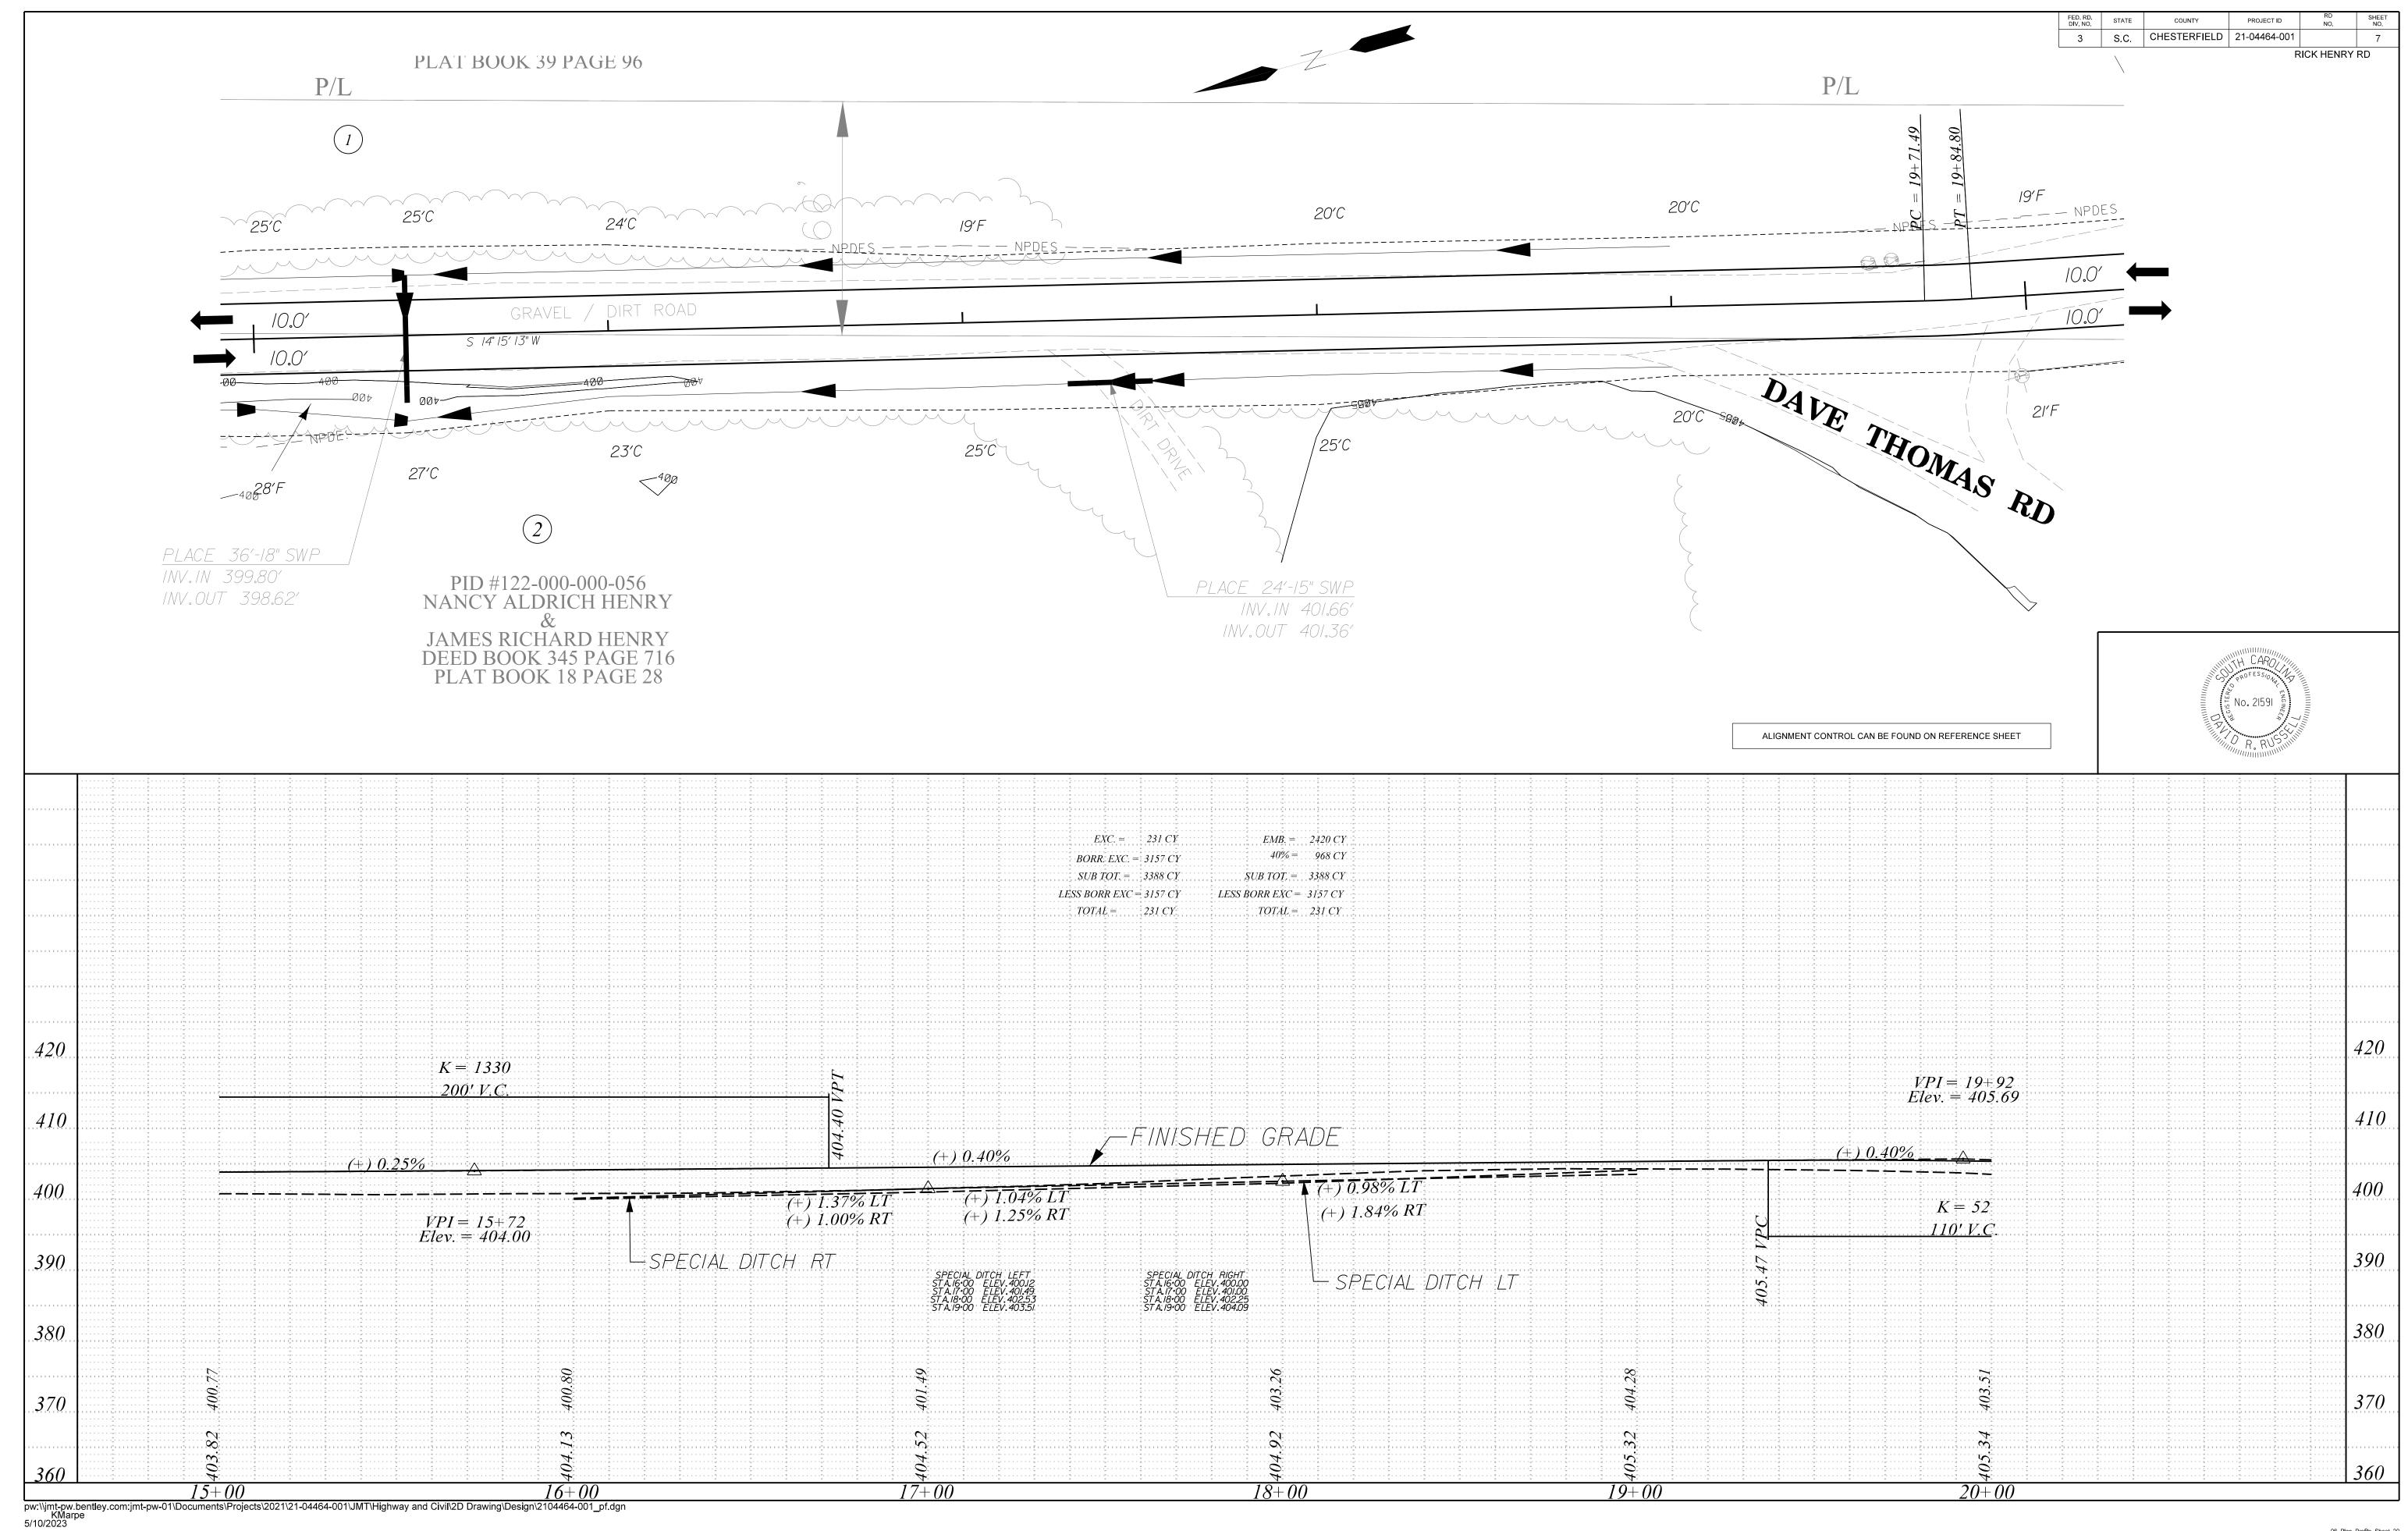

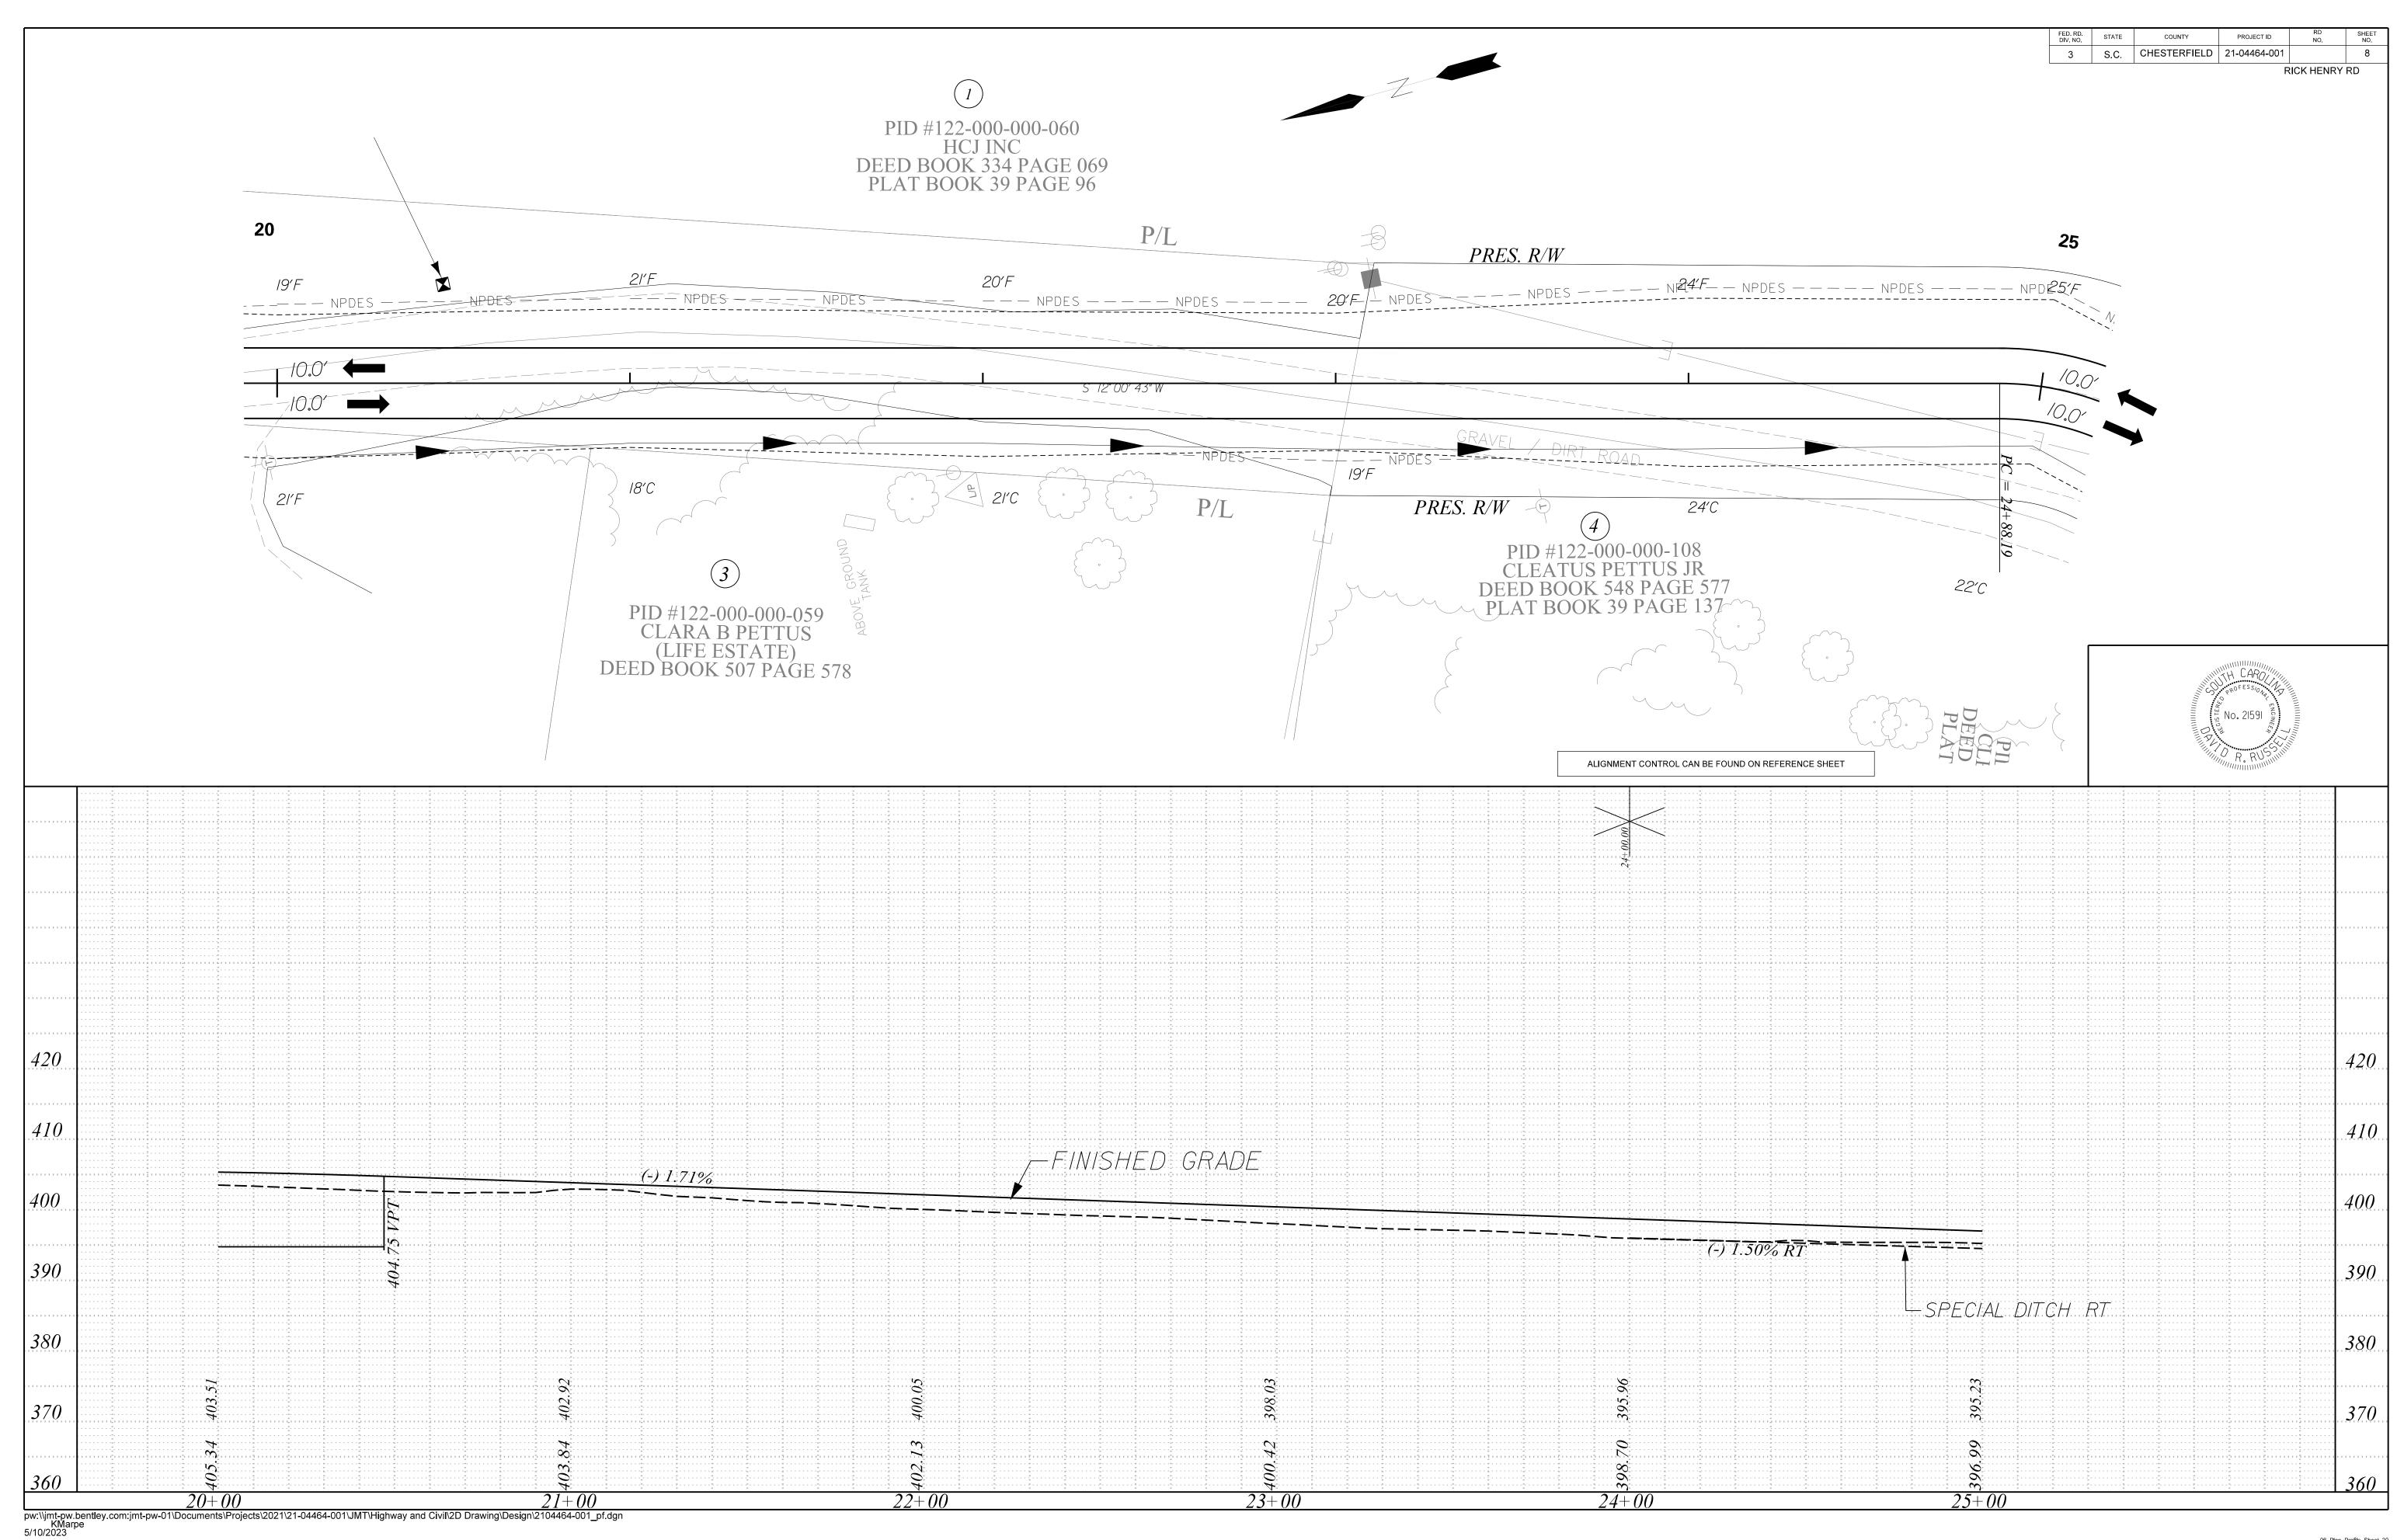

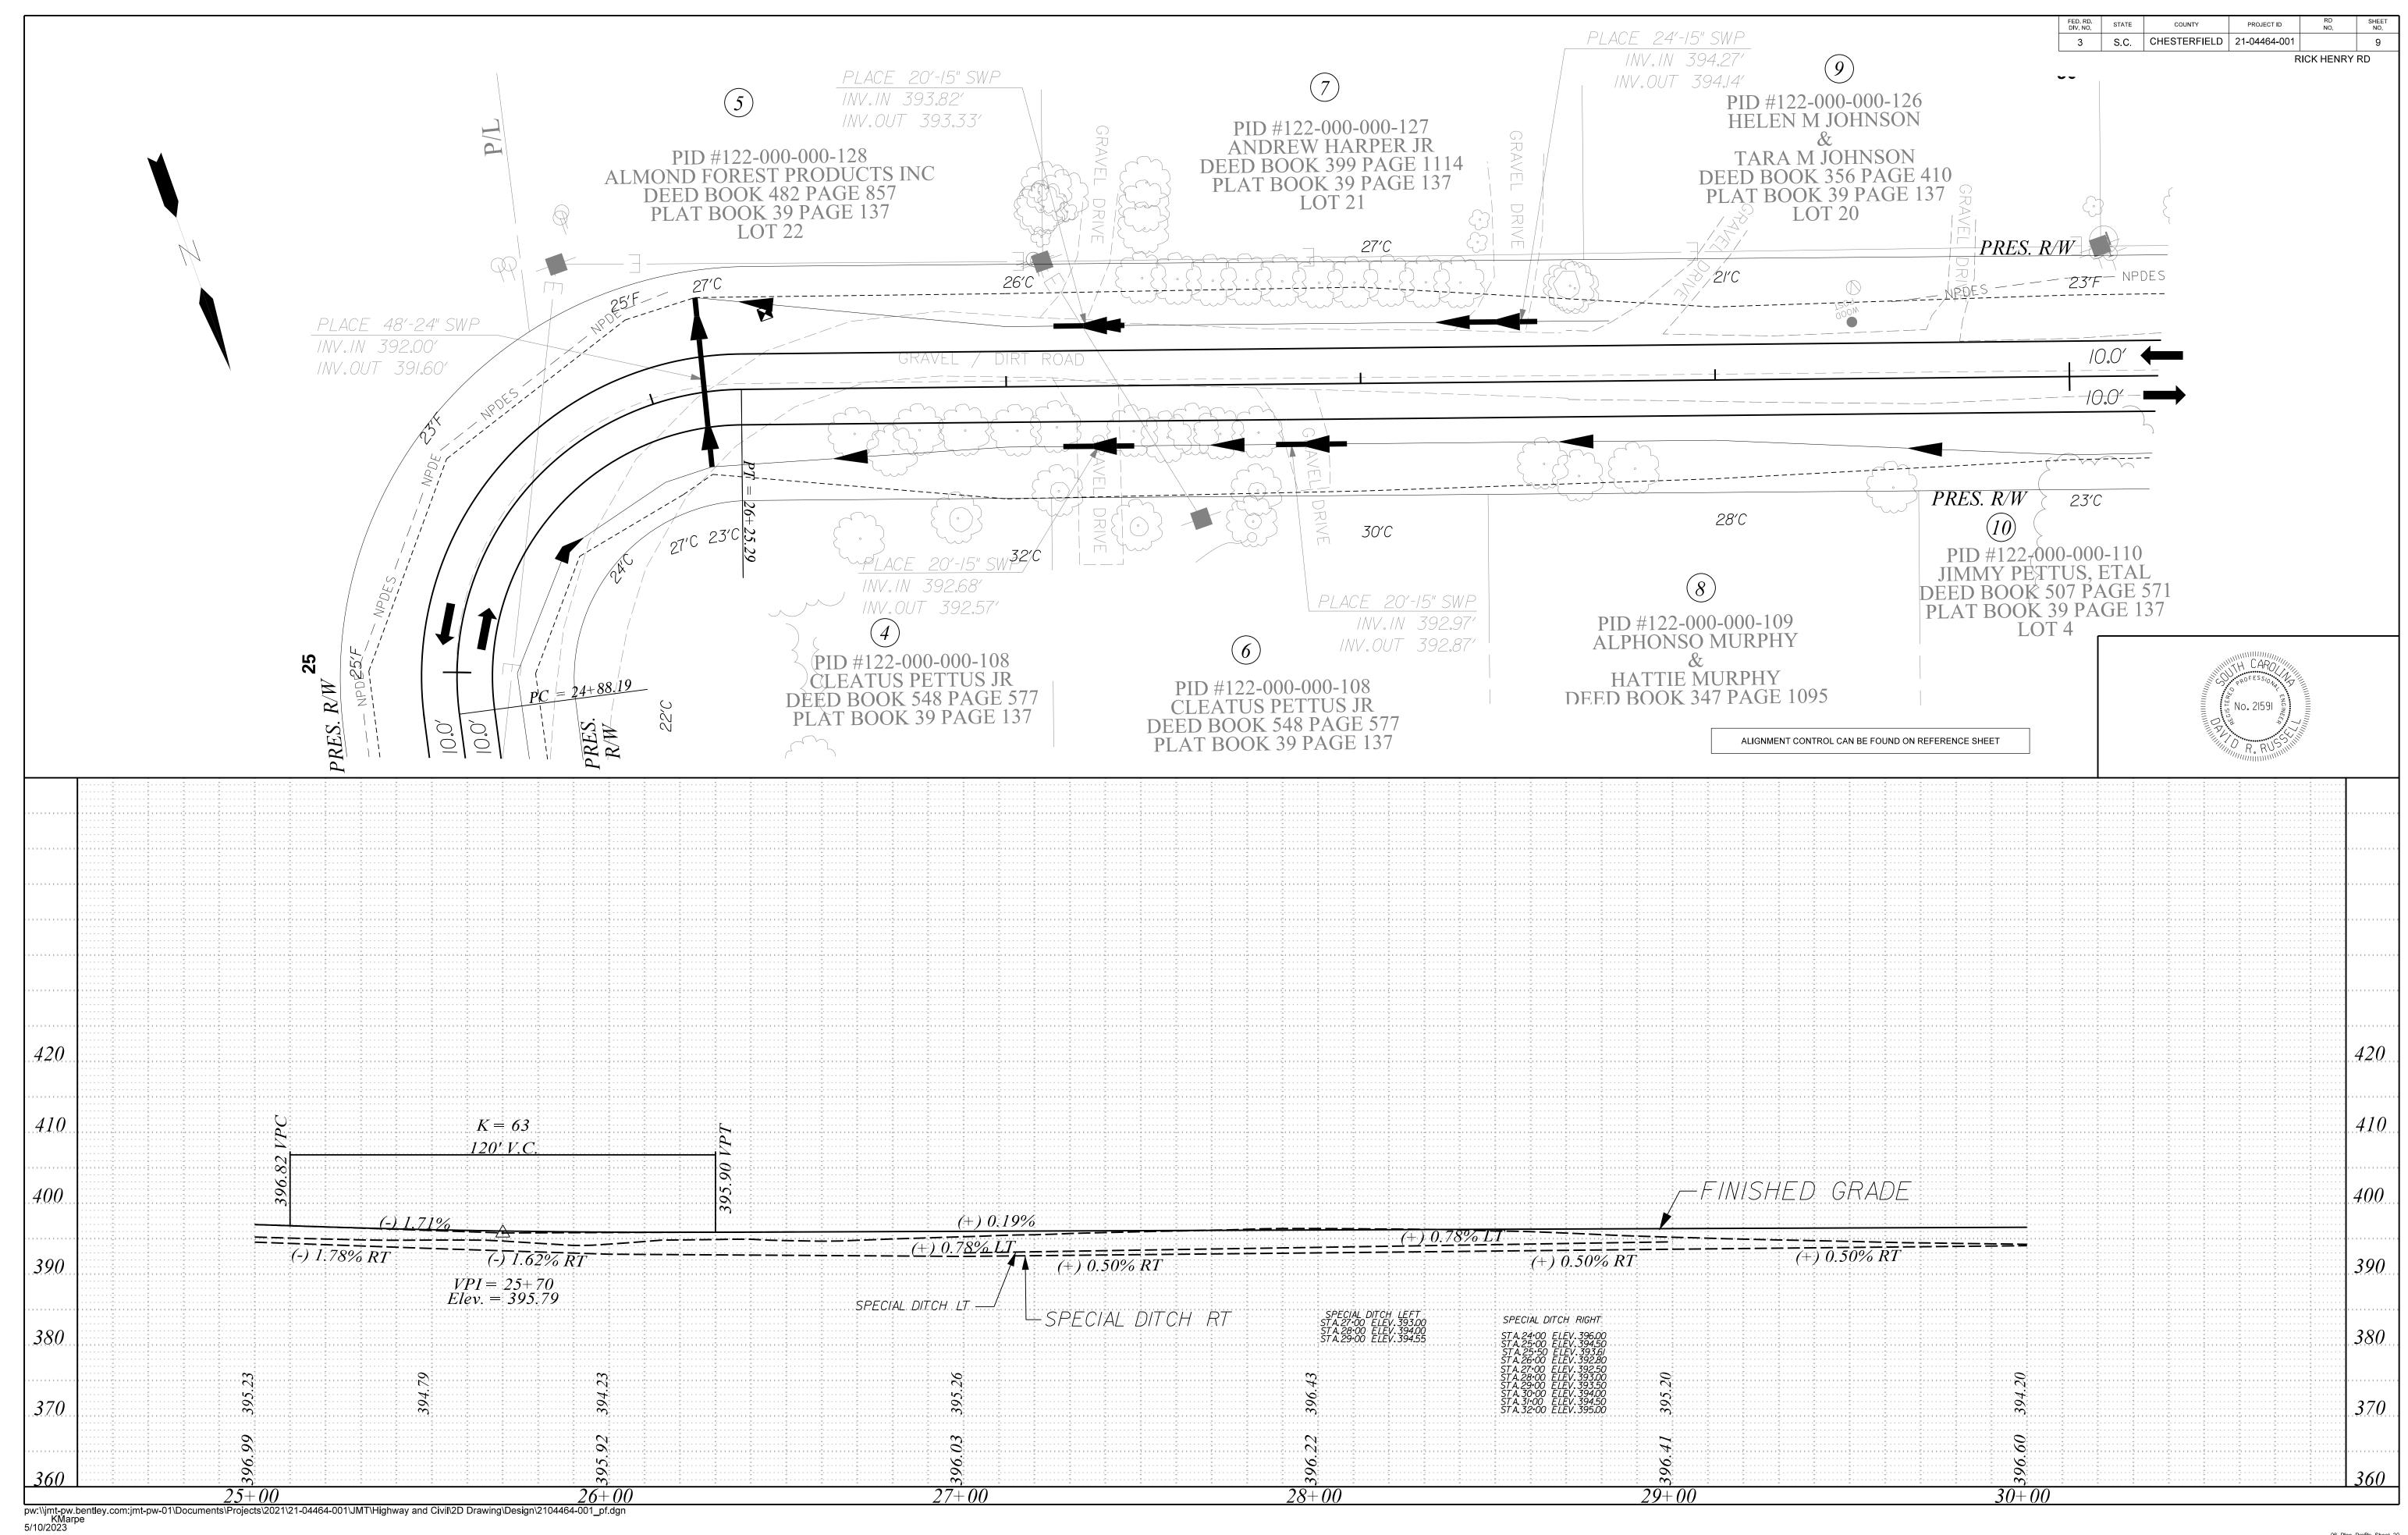

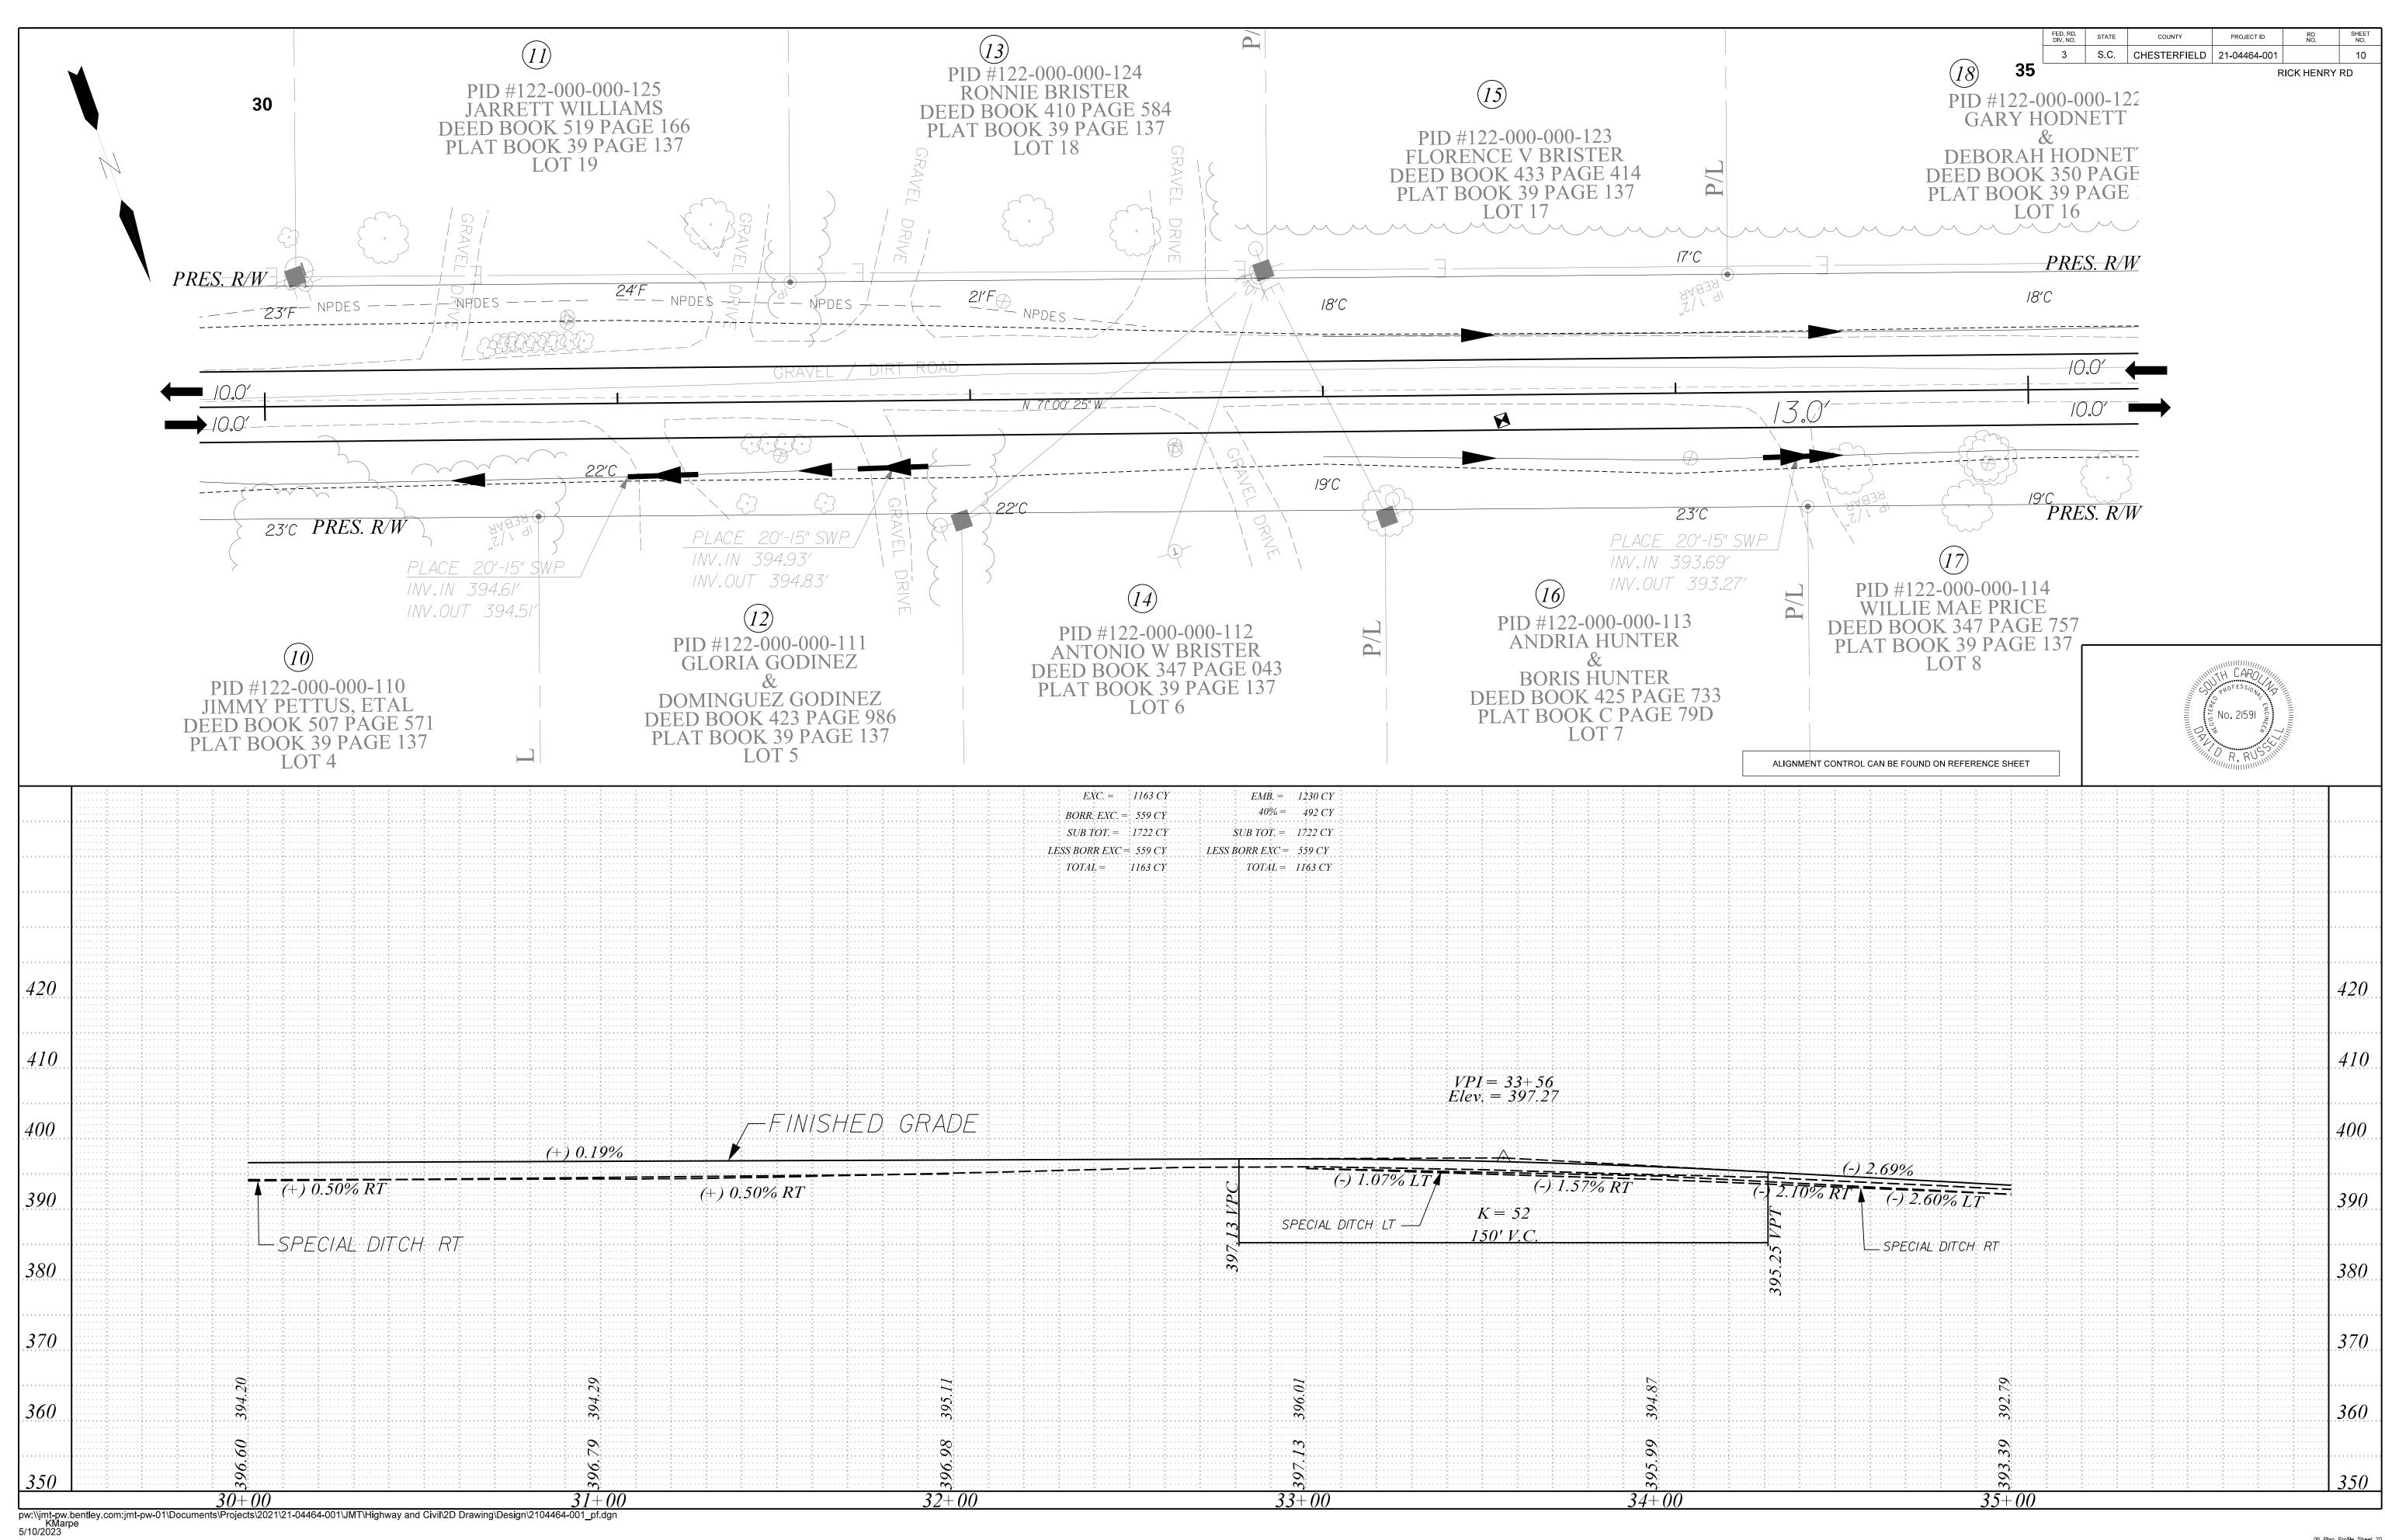

EROSION AND SEDIMENTATION CONTROL NOTES

FED.RD. DIV.NO	STATE	COUNTY	PROJECT ID	ROAD/ROUTE NO.	SHEET NO.
3	3 S.C. CHESTERFIELD		21-04464-001		EC-1

RICK HENRY ROAD

EROSION AND SEDIMENTATION CONTROL GENERAL

- 1. IF NECESSARY, SLOPES, WHICH EXCEED EIGHT (8) VERTICAL FEET SHOULD BE STABILIZED WITH SYNTHETIC OR VEGETATIVE MATS, IN ADDITION TO HYDROSEEDING.IT MAY BE NECESSARY TO INSTALL TEMPORARY SLOPE DRAINS DURING CONSTRUCTION. TEMPORARY BERMS MAY BE NEEDED UNTIL THE SLOPE IS BROUGHT TO GRADE.
- 2. STABILIZATION MEASURES SHALL BE INITIATED AS SOON AS PRACTICABLE IN PORTIONS OF THE SITE WHERE CONSTRUCTION ACTIVITIES HAVE TEMPORARILY OR PERMANENTLY CEASED, BUT IN NO CASE MORE THAN FOURTEEN (14) DAYS AFTER WORK HAS CEASED, EXCEPT AS STATED BELOW.
- ? WHERE STABILIZATION BY THE 14TH DAY IS PRECLUDED BY SNOW COVER OR FROZEN GROUND CONDITIONS STABILIZATION MEASURES MUST BE INITIATED AS SOON AS PRACTICABLE.
- ? WHERE CONSTRUCTION ACTIVITY ON A PORTION OF THE SITE IS TEMPORARILY CEASED, AND EARTH-DISTURBING ACTIVITIES WILL BE RESUMED WITHIN 14 DAYS, TEMPORARY STABILIZATION MEASURES DO NOT HAVE TO BE INITIATED ON THAT PORTION OF THE SITE.
- 3. ALL SEDIMENT AND EROSION CONTROL DEVICES SHALL BE INSPECTED ONCE EVERY CALENDAR WEEK. IF PERIODIC INSPECTION OR OTHER INFORMATION INDICATES THAT A BMP HAS BEEN INAPPROPRIATELY. OR INCORRECTLY CONSTRUCTED, THE PERMITTEE MUST ADDRESS THE NECESSARY REPLACEMENT OR MODIFICATION REQUIRED TO CORRECT THE BMP WITHIN 48 HOURS OF IDENTIFICATION.
- 4. PROVIDE SILT FENCE AND/OR OTHER CONTROL DEVICES, AS MAY BE REQUIRED, TO CONTROL SOIL EROSION DURING UTILITY CONSTRUCTION. ALL DISTURBED AREAS SHALL BE CLEANED, GRADED, AND STABILIZED WITH GRASSING IMMEDIATELY AFTER THE UTILITY INSTALLATION. FILL, COVER. AND TEMPORARY SEEDING AT THE END OF EACH DAY ARE RECOMMENDED. IF WATER IS ENCOUNTERED WHILE TRENCHING, THE WATER SHOULD BE FILTERED TO REMOVE ANY SEDIMENTS BEFORE BEING PUMPED
- BACK INTO ANY WATERS OF THE STATE. 5. ALL EROSION CONTROL DEVICES SHALL BE PROPERLY MAINTAINED DURING ALL PHASES OF CONSTRUCTION UNTIL THE COMPLETION OF ALL CONSTRUCTION ACTIVITIES AND ALL DISTURBED AREAS HAVE BEEN STABILIZED, ADDITIONAL CONTROL DEVICES MAY BE REQUIRED DURING CONSTRUCTION IN ORDER TO CONTROL EROSION AND/OR OFFSITE SEDIMENTATION. ALL TEMPORARY CONTROL DEVICES SHALL BE REMOVED
- ONCE CONSTRUCTION IS COMPLETE AND THE SITE IS STABILIZED. 6. THE CONTRACTOR MUST TAKE NECESSARY ACTION TO MINIMIZE THE TRACKING OF MUD ONTO PAVED ROADWAY(S) FROM CONSTRUCTION AREAS AND THE GENERATION OF DUST. THE CONTRACTOR SHALL DAILY REMOVE MUD/SOIL FROM PAVEMENT, AS MAY BE REQUIRED.
- 7. RESIDENTIAL SUBDIVISIONS REQUIRE EROSION CONTROL FEATURES FOR INFRASTRUCTURE AS WELL AS FOR INDIVIDUAL LOT CONSTRUCTION. INDIVIDUAL PROPERTY OWNERS SHALL FOLLOW THESE PLANS DURING CONSTRUCTION OR OBTAIN APPROVAL OF AN INDIVIDUAL PLAN IN ACCORDANCE WITH S.C REG. 72-300 ET SEQ. AND SCR100000.
- 8. TEMPORARY DIVERSION BERMS AND/OR DITCHES WILL BE PROVIDED AS NEEDED DURING CONSTRUCTION TO PROTECT WORK AREAS FROM UPSLOPE RUNOFF AND/OR TO DIVERT SEDIMENT-LADEN WATER TO APPROPRIATE TRAPS OR STABLE OUTLETS.
- 9. ALL WATERS OF THE STATE (WOS), INCLUDING WETLANDS, ARE TO BE FLAGGED OR OTHERWISE CLEARLY MARKED IN THE FIELD. A DOUBLE ROW OF SILT FENCE IS TO BE INSTALLED IN ALL AREAS WHERE A 50-FOOT BUFFER CAN $\frac{1}{2}$ T BE MAINTAINED BETWEEN THE DISTURBED AREA AND ALL WOS. A 10-FOOT BUFFER SHOULD BE MAINTAINED BETWEEN THE LAST ROW OF SILT FENCE AND ALL WOS.
- 10.LITTER, CONSTRUCTION DEBRIS, OILS, FUELS, AND BUILDING PRODUCTS WITH SIGNIFICANT POTENTIAL FOR IMPACT (SUCH AS STOCKPILES OF FRESHLY TREATED LUMBER) AND CONSTRUCTION CHEMICALS THAT COULD BE EXPOSED TO STORM WATER MUST BE PREVENTED FROM BECOMING A POLLUTANT SOURCE IN STORM WATER DISCHARGES.
- 11. A COPY OF THE SWPPP, INSPECTION RECORDS, AND RAINFALL DATA MUST BE RETAINED AT THE CONSTRUCTION SITE OR A NEARBY LOCATION EASILY ACCESSIBLE DURING NORMAL BUSINESS HOURS, FROM THE DATE OF COMMENCEMENT OF CONSTRUCTION ACTIVITIES TO THE DATE THAT FINAL STABILIZATION IS REACHED.
- 12.INITIATE STABILIZATION MEASURES ON ANY EXPOSED STEEP SLOPE (3H:1V OR GREATER) WHERE LAND-DISTURBING ACTIVITIES HAVE PERMANENTLY OR TEMPORARILY CEASED, AND WILL NOT RESUME FOR A PERIOD OF 7 CALENDAR DAYS.
- 13.MINIMIZE SOIL COMPACTION AND, UNLESS INFEASIBLE, PRESERVE
- TOPSOIL. UPDATED 2/6/13 14.MINIMIZE THE DISCHARGE OF POLLUTANTS FROM EQUIPMENT AND VEHICLE WASHING, WHEEL WASH WATER, AND OTHER WASH WATERS. WASH WATERS MUST BE TREATED IN A SEDIMENT BASIN OR ALTERNATIVE CONTROL THAT PROVIDES EQUIVALENT OR BETTER TREATMENT PRIOR TO
- 15.MINIMIZE THE DISCHARGE OF POLLUTANTS FROM DEWATERING OF TRENCHES AND EXCAVATED AREAS. THESE DISCHARGES ARE TO BE ROUTED THROUGH APPROPRIATE BMPS (SEDIMENT BASIN, FILTER BAG, ETC.).
- 16. THE FOLLOWING DISCHARGES FROM SITES ARE PROHIBITED: WASTEWATER FROM WASHOUT OF CONCRETE, UNLESS MANAGED BY AN APPROPRIATE CONTROL; WASTEWATER FROM WASHOUT AND CLEANOUT OF STUCCO. PAINT, FORM RELEASE OILS, CURING COMPOUNDS AND OTHER CONSTRUCTION MATERIALS; FUELS, OILS, OR OTHER POLLUTANTS USED IN VEHICLE AND EQUIPMENT OPERATION AND MAINTENANCE; AND SOAPS OR SOLVENTS USED IN VEHICLE AND EQUIPMENT WASHING
- 17.AFTER CONSTRUCTION ACTIVITIES BEGIN, INSPECTIONS MUST BE CONDUCTED AT A MINIMUM OF AT LEAST ONCE EVERY CALENDAR WEEK AND MUST BE CONDUCTED UNTIL FINAL STABILIZATION IS REACHED ON ALL AREAS OF THE CONSTRUCTION SITE
- 18.IF EXISTING BMPS NEED TO BE MODIFIED OR IF ADDITIONAL BMPS ARE NECESSARY TO COMPLY WITH THE REQUIREMENTS OF THIS PERMIT AND/OR SC\32 S WATER QUALITY STANDARDS, IMPLEMENTATION MUST BE COMPLETED BEFORE THE NEXT STORM EVENT WHENEVER PRACTICABLE. IF IMPLEMENTATION BEFORE THE NEXT STORM EVENT IS IMPRACTICABLE, THE SITUATION MUST BE DOCUMENTED IN THE SWPPP AND ALTERNATIVE BMPS MUST BE IMPLEMENTED AS SOON AS REASONABLY POSSIBLE.
- 19.A PRE-CONSTRUCTION CONFERENCE MUST BE HELD FOR EACH CONSTRUCTION SITE WITH AN APPROVED ON-SITE SWPPP PRIOR TO THE IMPLEMENTATION OF CONSTRUCTION ACTIVITIES. FOR NON-LINEAR PROJECTS THAT DISTURB 10 ACRES OR MORE THIS CONFERENCE MUST BE HELD ON-SITE UNLESS CHESTERFIELD COUNTY HAS APPROVED OTHERWISE.
- 20. CONTRACTORS ARE REQUIRED TO HAVE RAIN GAUGES AT THE CONSTRUCTION SITE AND THE RAIN TOTALS DOCUMENTED FOR REVIEW BY CHESTERFIELD COUNTY AND SCDHEC.
- 21.A PRE-CONSTRUCTION CONFERENCE MUST BE HELD WITH CHESTERFIELD COUNTY AT LEAST 48 HOURS PRIOR TO BEGINNING ANY LAND DISTURBING ACTIVITIES. THE OWNER, DESIGN ENGINEER AND CONTRACTOR MUST BE PRESENT AND HAVE OBTAINED THE STORMWATER PERMIT, STAMPED APPROVED PLANS AND THE N.O.I APPROVAL LETTER FROM SCDHEC BEFORE CALLING CHESTERFIELD COUNTY AT 843-623-2464 TO SCHEDULE THIS
- 22. PORTABLE TOILET FACILITIES SHALL NOT BE LOCATED WITHIN 20 FEET OF ANY STORM WATER STRUCTURE AND/OR 50 FEET OF ANY WATER COURSE, WETLAND AREA, STREAM, FLOODPLAIN, OR LAKE.

CONSTRUCTION SEQUENCE

DESCRIBED IN EACH STAGE.

CONSTRUCTION SEQUENCE ALL EARTH DISTURBANCE ACTIVITIES SHALL PROCEED IN ACCORDANCE WITH THE FOLLOWING SEQUENCE. EACH STAGE SHALL BE COMPLETED BEFORE ANY FOLLOWING STAGE IS INITIATED. CLEARING AND GRUBBING SHALL BE UNITED TO THOSE AREAS

IMMEDIATELY UPON DISCOVERING UNFORESEEN CIRCUMSTANCES POSING POTENTIAL FOR ACCELERATED EROSION AND/OR SEDIMENT POLLUTION, THE OPERATOR SHALL IMPLEMENT APPROPRIATE BEST MANAGEMENT PRACTICES TO ELIMINATE THE POTENTIAL FOR ACCELERATED EROSION AND/OR SEDIMENT POLLUTION. BEFORE IMPLEMENTING ANY REVISIONS TO THE APPROVED EROSION AND SEDIMENT CONTROL PLAN, OR REVISIONS TO THE OTHER PLANS WHICH MAY AFFECT THE EFFECTIVENESS OF THE APPROVED EROSION AND SEDIMENT POLLUTION CONTROL PLAN, THE OPERATOR MUST RECEIVE APPROVAL OF THE REVISION FROM THE JURIDICTIONAL CONSERVATION DISTRICT. RUNOFF ACCUMULATING IN EXCAVATED AREAS SHALL EITHER REMAIN IN THE EXCAVATED AREA IN ORDER TO INFILTRATE THE RUNOFF, OR BE DIRECTED TO AN APPROVED E&S CONTROL MEASURE TO ENSURE RUNOFF IS TREATED BEFORE LEAVING THE DISTURBED SITE OR WILL BE INFILTRATED BACK INTO THE GROUND. E&S CONTROL BMPS WILL BE MAINTAINED TO PERFORM AS DESIGNED IN THESE INSTANCES. CONSTRUCTION ACTIVITIES WITHIN EACH STAGE MAY OVERLAP IF WORK WITHIN EACH AREA IS CARRIED OUT IN SEQUENCE.

EACH STAGE OF THE SEQUENCE OF CONSTRUCTION MUST BE COMPLETED PRIOR TO INITIATION OF THE NEXT STAGE OF THE SEQUENCE OF CONSTRUCTION.

NOTE: PRIOR TO ANY GRADING, CREEK BOUNDARIES AND TOP OF BANK ARE TO BE FIELD DELINEATED AND STAKED WITH ORANGE CONSTRUCTION FENCE TO AVOID DISTURBANCE.

- ALL BLASTING ACTIVITY, IF REQUIRED, SHOULD BE DONE IN ACCORDANCE WITH THE LOCAL, STATE AND FEDERAL REGULATIONS. CONTRACTOR SHOULD NOTIFY OWNER AND ALL REGULATORY AGENCIES IN WRITING AND OBTAIN ANY NECESSARY PERMITS PRIOR TO ANY BLASTING ACTIVITIES. SITE CONSTRUCTION - GENERAL
- 1. CONDUCT PRE-CONSTRUCTION MEETING. LOCAL DHEC EQC OFFICE SHALL BE NOTIFIED 48 HOURS PRIOR TO BEGINNING LAND
- DISTURBING ACTIVITIES. 2. FIELD MARK EXISTING UTILITIES AND LIMITS OF DISTURBANCE PRIOR TO EARTH DISTURBANCE. 3. INSTALL ROCK CONSTRUCTION ENTRANCE BEFORE INITIAL
- DISTURBANCES. ALL VEHICLES ENTERING THE SITE SHALL DO SO VIA THE ROCK CONSTRUCTION ENTRANCE. 4. INSTALL PERIMETER SUPPORTED SILT FENCE DOWNSLOPE OF PROPOSED CONSTRUCTION ACTIVITY AT LOCATIONS INDICATED.
- PLACE SILT FENCE ON LEVEL GRADE WHERE POSSIBLE. CARE SHOULD BE TAKEN TO PROTECT THE STREAM AND WETLANDS FROM ANY SEDIMENT POLLUTION. THE CONTRACTOR SHALL MAINTAIN THE SILT FENCE IN WORKING ORDER THROUGHOUT THE COURSE OF CONSTRUCTION, MAKING INSPECTIONS AFTER EACH RAINFALL EVENT AND MAKING ANY NECESSARY REPAIRS.
- 5. EARTH AND TOPSOIL TO BE RETAINED ON THE SITE SHALL BE STOCKPILED IN THE WITHIN THE LIMITS OF DISTURBANCE AS APPROVED BY THE ENGINEER OR OFF-HAULED. IMMEDIATELY INSTALL SILT FENCE AROUND STOCKPILES, SOW TEMPORARY SEED AND MULCH STOCKPILES TO ENSURE PROTECTION AGAINST
- SEDIMENT RUNOFF FROM THE TOPSOIL STOCKPILE 6. LIMIT CLEARING, GRUBBING AND TOPSOIL STRIPPING TO THE IMMEDIATE AREA REQUIRED TO CONSTRUCT ROADSIDE DITCHES
- AND INSTALL STORM SEWER SYSTEM. 7. EXCAVATE AND CONSTRUCT ROADSIDE DITCHES AND STONE TRENCHES WHERE SHOWN ON THE PLANS. IMMEDIATELY ADD PERMANENT TOPSOIL, AND SEED. STABILIZE IMMEDIATELY WITH DITCH LINING AND PLACEMENT OF TEMPORARY SEDIMENT TUBES AND ROCK SEDIMENT DIKE AS SHOWN ON THE PLANS. PROTECT STONE TRENCH FROM SILT BUILD-UP AND COMPACTION. CONSTRUCT STORM SEWER SYSTEM, DRIVEWAY CULVERTS AND OUTLET PROTECTION TO LINES AND GRADES AS SHOWN ON THE PLANS. WORK SHALL BEGIN AT THE OUTLET AND WORK UPSTREAM. REMOVE EXISTING CULVERTS WHERE SHOWN ON THE PLANS.
- 8. AT ALL TIMES, MAINTAIN TEMPORARY INGRESS AND EGRESS ACCESS TO ADJACENT PROPERTIES. 9. ROUGH GRADE SUBGRADE TO PLAN LINE AND GRADES. EXCESS
- MATERIAL TO BE HAULED OFF-SITE. 10. PLACE AND COMPACT BASE MATERIAL AND INSTALL PAVING FABRIC, IF CALLED FOR IN THE PLANS. 11.PLACE ASPHALT CONCRETE SURFACE COURSE ON ROAD AND AT
- EXISTING DRIVEWAYS. DRIVEWAYS TO MAINTAIN EXISTING WIDTH AND BE PAVED TO THE RIGHT-OF-WAY-LINE. 12. FINAL GRADE SHOULDER AND RELOCATE MAIL BOXES AS
- 13. PROVIDE REMAINING PERMANENT SEEDING AND MULCHING. COMPLETE ALL ON-SITE IMPROVEMENTS AND PERFORM AND
- 15. UNTIL SUCH TIME AS THE SITE IS PERMANENTLY STABILIZED, ALL EROSION AND SEDIMENT CONTROL DEVICES SHALL MAINTAINED IN WORKING ORDER. MAINTENANCE SHALL INCLUDE INSPECTION OF ALL EROSION AND SEDIMENT CONTROL DEVICES
- AFTER EACH RUNOFF EVENT AND ON A WEEKLY BASIS. 16. PERMANENT STABILIZATION IS DEFINED AS A MINIMUM UNIFORM 70% PERENNIAL VEGETATIVE COVER OR OTHER PERMANENT NON-VEGETATIVE COVER WITH A DENSITY SUFFICIENT TO RESIST ACCELERATED SURFACE EROSION AND SUBSURFACE CHARACTERISTICS SUFFICIENT TO RESIST SLIDING OR OTHER MOVEMENTS.
- 17. CONTACT CHESTERFIELD COUNTY FOR FINAL INSPECTION AND CLOSE OUT OF PROJECT 18. UPON COMPLETION OF ALL EARTH DISTURBANCE ACTIVITIES AND PERMANENT STABILIZATION OF ALL DISTURBED AREAS,
- REMOVE THE TEMPORARY BMPS. 19. IMMEDIATELY REPAIR AND STABILIZE ANY AREAS DISTURBED DURING REMOVAL OF THE TEMPORARY BMPS.

INSPECTION AND MAINTENANCE PLAN

- 1. ALL EROSION AND SEDIMENT CONTROL PRACTICES SHALL BE CHECKED FOR STABILITY AND OPERATION FOLLOWING EVERY RUNOFF-PRODUCING RAINFALL BUT IN NO CASE LESS THAN ONCE EVERY WEEK. ANY NEEDED REPAIRS SHALL BE MADE IMMEDIATELY TO MAINTAIN ALL PRACTICES AS
- 2. CONSTRUCTION EQUIPMENT SHALL NOT BE STORED OVERNIGHT OR FUELED ON SITE WITHOUT THE CONSENT OF THE COUNTY.

INSPECTION AND MAINTENANCE

- a. INSPECT EVERY 7 CALENDAR DAYS AND WITHIN 24-HOURS AFTER EACH RAINFALL EVENT THAT PRODUCES 5% -INCHES OR MORE OF PRECIPITATION. CHECK FOR SEDIMENT BUILDUP AND FENCE INTEGRITY. CHECK WHERE RUNOFF HAS ERODED A CHANNEL BENEATH THE FENCE, OR WHERE THE
- FENCE HAS SAGGED OR COLLAPSED BY FENCE OVERTOPPING. 6. IF THE FENCE FABRIC TEARS, BEGINS TO DECOMPOSE, OR IN ANY WAY BECOMES INEFFECTIVE, REPLACE THE SECTION OF FENCE IMMEDIATELY.
- c. REMOVE SEDIMENT ACCUMULATED ALONG THE FENCE WHEN IT REACHES 1/3 THE HEIGHT OF THE FENCE, ESPECIALLY IF HEAVY RAINS ARE
- d. REMOVE TRAPPED SEDIMENT FROM THE SITE OR STABILIZE IT ON SITE. e. REMOVE SILT FENCE WITHIN 30 DAYS AFTER FINAL STABILIZATION IS ACHIEVED OR AFTER TEMPORARY BEST MANAGEMENT PRACTICES (BMPS) ARE
- NO LONGER NEEDED f. PERMANENTLY STABILIZE DISTURBED AREAS RESULTING FROM FENCE
- ROCK DITCH CHECK. a. INSPECT EVERY 7 CALENDAR DAYS AND WITHIN 24-HOURS AFTER EACH RAINFALL EVENT THAT PRODUCES 5%4 -INCHES OR MORE OF PRECIPITATION. 6. INSPECT FOR SEDIMENT AND DEBRIS ACCUMULATION.
- c. INSPECT ROCK CHECK DAM EDGES FOR EROSION AND REPAIR PROMPTLY AS REQUIRED.
- d. REMOVE SEDIMENT WHEN IT REACHES 1/3 THE ORIGINAL CHECK HEIGHT. e. IN THE CASE OF GRASS-LINED DITCHES AND SWALES, REMOVE ROCK CHECK DAMS WHEN THE GRASS HAS MATURED SUFFICIENTLY TO PROTECT THE DITCH OR SWALE UNLESS THE SLOPE OF THE SWALE IS GREATER THAN
- f. AFTER CONSTRUCTION IS COMPLETE, REMOVE STONE IF VEGETATION IS USED FOR PERMANENT STABILIZATION.
- g. SEED AND MULCH THE AREA BENEATH THE ROCK DITCH CHECKS IMMEDIATELY AFTER DAM REMOVAL.

- a. INSPECT SEDIMENT TUBES AFTER INSTALLATION FOR GAPS UNDER THE SEDIMENT TUBES AND FOR GAPS BETWEEN THE JOINTS OF ADJACENT ENDS
- 6. INSPECT EVERY 7-DAYS AND WITHIN 24-HOURS OF A RAINFALL EVENT
- OF Ø.5-INCHES OR GREATER. c. REPAIR ALL RILLS, GULLIES, AND UNDERCUTTING NEAR SEDIMENT
- d. REMOVE ALL SEDIMENT DEPOSITS THAT IMPAIR THE FILTRATION CAPABILITY OF SEDIMENT TUBES WHEN THE SEDIMENT REACHES 1/3 THE HEIGHT OF THE EXPOSED SEDIMENT TUBE.
- e. REMOVE AND/OR REPLACE INSTALLED SEDIMENT TUBES AS REQUIRED TO ADAPT TO CHANGING CONSTRUCTION SITE CONDITIONS.
- f. REMOVE SEDIMENT TUBES FROM THE SITE WHEN THE FUNCTIONAL LONGEVITY IS EXCEEDED AS DETERMINED BY THE ENGINEER, INSPECTOR OR MANUFACTURER'S REPRESENTATIVE. GATHER SEDIMENT TUBES AND DISPOSE OF THEM IN REGULAR MEANS AS NON-HAZARDOUS, INERT
- g. PRIOR TO FINAL STABILIZATION, BACKFILL ALL TRENCHES. DEPRESSIONS AND OTHER GROUND DISTURBANCES CAUSED BY THE REMOVAL OF SEDIMENT TUBES.

- STABILIZED CONSTRUCTION ENTRANCE. a. INSPECT EVERY 7 CALENDAR DAYS AND WITHIN 24-HOURS AFTER EACH RAINFALL EVENT THAT PRODUCES 5 -INCHES OR MORE OF PRECIPITATION, OR AFTER HEAVY USE.
- 6. CHECK FOR MUD AND SEDIMENT BUILDUP AND PAD INTEGRITY c. MAKE DAILY INSPECTIONS DURING PERIODS OF WET WEATHER. MAINTENANCE IS REQUIRED MORE FREQUENTLY IN WET WEATHER CONDITIONS. RESHAPE THE STONE PAD AS NEEDED FOR DRAINAGE AND
- RUNOFF CONTROL. d. WASH OR REPLACE STONES AS NEEDED.
- TEMPORARY SEDIMENT TRAP a. REMOVE SEDIMENT WHEN IT REACHES 50 PERCENT OF STORAGE VOLUME OR TOP OF CLEANOUT STAKE.
- b. INSPECT EVERY 7 CALENDAR DAYS AND WITHIN 24-HOURS AFTER EACH RAINFALL EVENT THAT PRODUCES 5%4 -INCHES OR MORE OF PRECIPITATION.
 c. REMOVE ALL TEMPORARY SEDIMENT TRAPS WITHIN 30 DAYS AFTER
- FINAL SITE STABILIZATION IS ACHIEVED OR AFTER IT IS NO LONGER d. REMOVE TRAPPED SEDIMENT FROM THE SITE, OR STABILIZED ON SITE.
- e. PERMANENTLY STABILIZED DISTURBED AREAS RESULTING FROM THE REMOVAL OF SEDIMENT TRAPS.

THE ESCAPE OF SEDIMENT FROM THE SITE SHALL BE PREVENTED BY THE INSTALLATION OF EROSION AND SEDIMENT CONTROL MEASURES AND PRACTICES PRIOR TO LAND DISTURBING ACTIVITIES. ANY CLEARING AND GRUBBING, EXCEPT WHAT IS NECESSARY TO ESTABLISH SEDIMENT CONTROL DEVICES SHALL NOT BEGIN UNTIL ALL SEDIMENT CONTROL DEVICES HAVE BEEN INSTALLED AND HAVE BEEN STABLIZED. EROSION CONTROL MEASURES WILL BE MAINTAINED AT ALL TIMES. IF FULL IMPLEMENTATION OF THE APPROVED PLAN DOES NOT PROVIDE FOR EFFECTIVE EROSION CONTROL. ADDITIONAL EROSION AND SEDIMENT CONTROL MEASURES SHALL BE IMPLEMENTED TO CONTROL OR TREAT THE SEDIMENT SOURCE.

CHARACTERISTICS SUFFICIENT TO RESIST SLIDING OR OTHER MOVEMENTS.

NPDES PERMIT REQUIREMENTS

- 1. THE PERMITTEE OR CO-PERMITTEE SHALL CONTACT THE PERMIT ISSUING AGENCY AT LEAST SEVEN DAYS PRIOR TO THE START OF CONSTRUCTION TO DETERMINE IF A PRE-CONSTRUCTION MEETING IS
- 2. THE PERMITTEE AND THE CO-PERMITTEE MUST ENSURE THAT VISUAL SITE INSPECTIONS ARE CONDUCTED WEEKLY, AND AFTER EACH PRECIPITATION EVENT BY QUALIFIED PERSONNEL TOASSURE THE
- EFFECTIVE OPERATION OF BMP'S. A WRITTEN ACCOUNT OF EACH INSPECTION AND THE CORRECTIVE ACTION TAKEN MUST BE KEPT ON SITE.

 3. WHERE BMP'S ARE FOUND TO BE INOPERATIVE OR HAVE FAILED THE PERMITTEE OR CO- PERMITTEE SHALL CONTACT THE PERMIT ISSUING AGENCY IMMEDIATELY, FOLLOWED BY A WRITTEN REPORT WITHIN FIVE
- DAYS OF INITIAL CONTACT. 4. THE PERMITTEE AND CO-PERMITTEE SHALL RETAIN RECORDS OF ALL MONITORING INFORMATION INCLUDING INSPECTION REPORTS AS
- FROM THE DATE OF THE TERMINA TION OF COVERAGE UNDER THIS PERMIT. 5. THE PERMITTEE AND CO-PERMITTEE SHALL TAKE ALL REASONABLE STEPS TO MINIMIZE ORPREVENT ANY DISCHARGE THAT HAS REASONABLE LIKELIHOOD OF ADVERSELY AFFECTING HUMAN HEALTH OR THE

REQUIRED BY THIS PERMIT FOR A PERIOD OF THREE YEARS


- ENVIRONMENT IN VIOLATION OF THIS PERMIT. 6. UPON REDUCTION, LOSS OR FAILURE OF A BMP, THE PERMITTEE AND CO-PERMITTEE SHALL TAKE IMMEDIATE ACTION TO RESTORE THE BMP TO NORMAL OPERAT ION OR PROVIDE AN ALTERNATIVE BMP SHALL BE
- EMPLOYED AND THE PERMIT ISSUING AGENCY CONTACTED 7. THE PERMITTEE AND CO-PERMITTEE MUST COMPLY WITH ALL TERMS AND CONDITIONS OF THE NPDES PERMIT. ANY PERMIT NONCOMPLIANCE MAY BE GROUNDS FOR ENFORCEMENT ACTION. THE PERMITTEE AND CO-PERMITTEE MAY BE SUBJECT TO CRIMINAL AND/OR CIVIL PENALTIES FOR VIOLATIONS OF THE TERMS AND CONDITIONS OF THIS
- PERMIT 8. THE OWNER OR OPERATOR OF THIS FACILITY COVERED BY THIS PERMIT SHALL MAKE THE PLANS AVAILABLE TO THE PUBLIC IF REQUESTED. EROSION AND SEDIMENT CONTROL PLANS MUST BE MADE AVAILABLE AT THE SITE AT ALL TIMES.
- 9. THE STAGING OF EARTH DISTURBANCE ACTIVITIES AND MAINTENANCE REQUIREMENTS CONTAINED IN THE E&S PLAN MUST BE FOLLOWED. UNLESS
- AMENDED AND APPROVED BY THE COUNTY OR DEP. 10. ALL BUILDING MATERIALS AND WASTES MUST BE REMOVED FROM THE SITE AND RECYCLED OR DISPOSED IN ACCORDANCE WITH THE SOLID WASTE MANAGEMENT REGULATIONS. NO MATERIALS MAY BE BURIED, DUMPED, OR DISCHARGED ON SITE.
- 11. AN EROSION AND SEDIMENT POLLUTION CONTROL PLAN SHALL BE DEVELOPED AND IMPLEMENTED FOR ALL OFF- SITE SPOIL AND BORROW AREAS. AREAS THAT ARE OUTSIDE OF THE ORIGINAL PERMIT BOUNDARIES OR NOT COVERED BY ANOTHER NPDES PERMIT WILL BE CONSIDERED A MAJOR REVISION TO THE PERMIT.


ERUSIUN AND	SEDIMENTATION	CONTROL	_EGEND	
DESCRIPTION	SYMBOL	DESCRIP	TION	SYMBOL
NPDES BOUNDARY = LIMITS OF DISTURBA SILT FENCE:	NCE NPDES	DITCH CH	IECK	
NAG S75 DITCH LINI APPROVED EQUIVALEN	NG, OR			
SEDIMENT TUBE:		CONSTRUCT	ION ENTRAN	ICE:
		OUTLET PR	ROTECTION	


EROSION AND SEDIMENTATION CONTROL DETAILS

FED.RD. DIV.NO	· STATE COUNTY		PROJECT ID	ROAD/ROUTE NO.	SHEET NO.
3	3 S.C. CHESTERFIELD		21-04464-001		EC-2

RICK HENRY ROAD

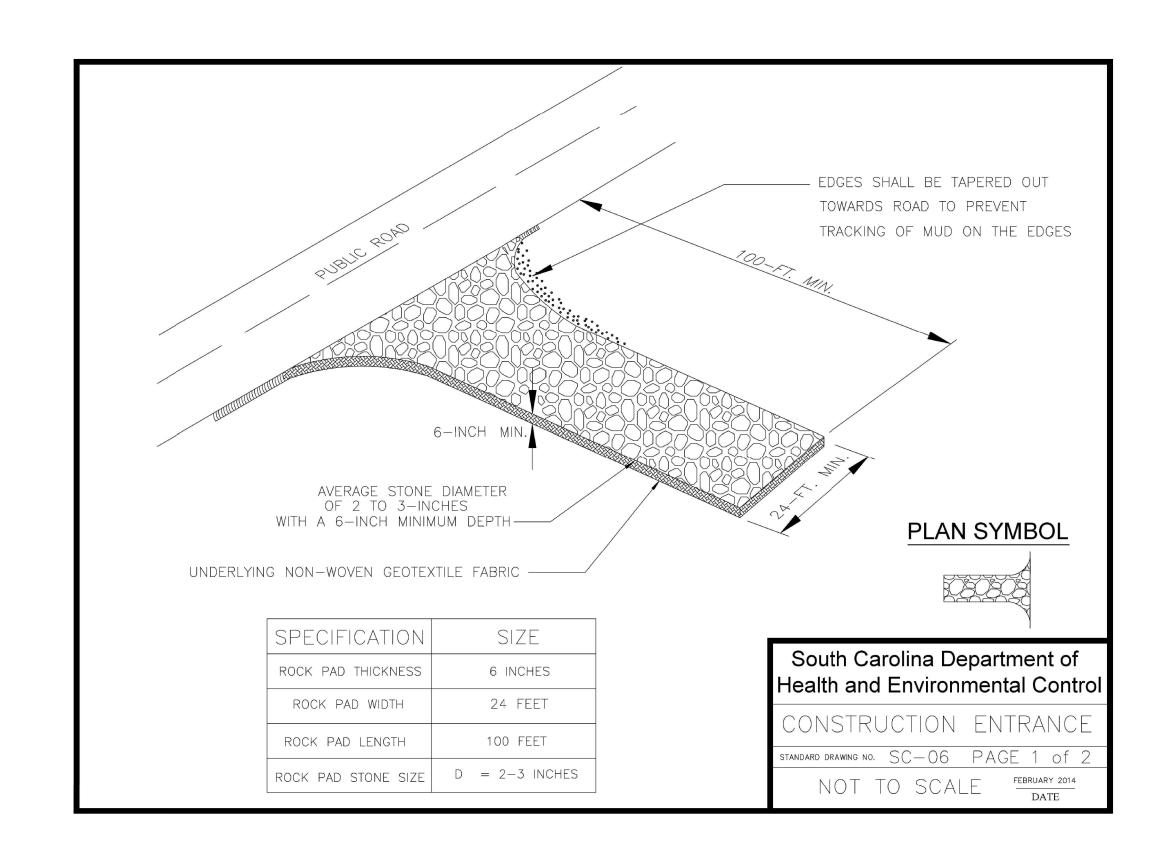

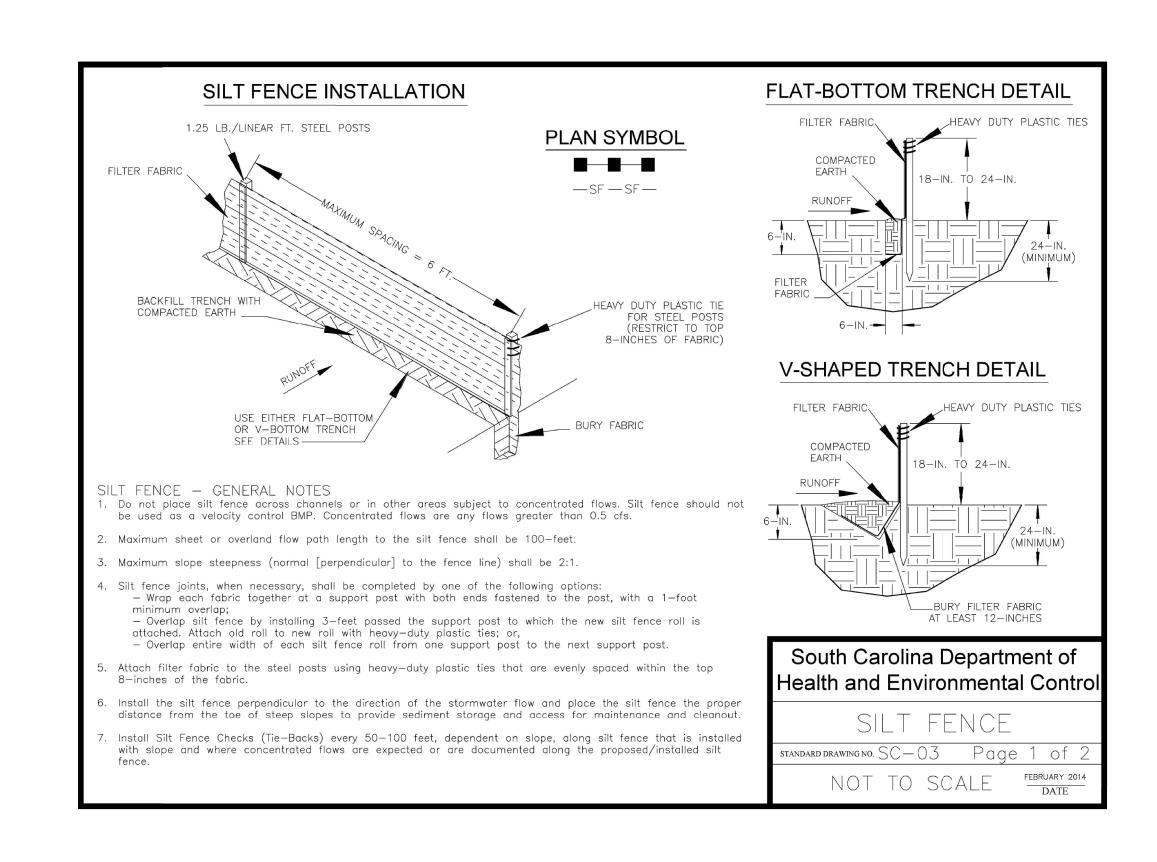


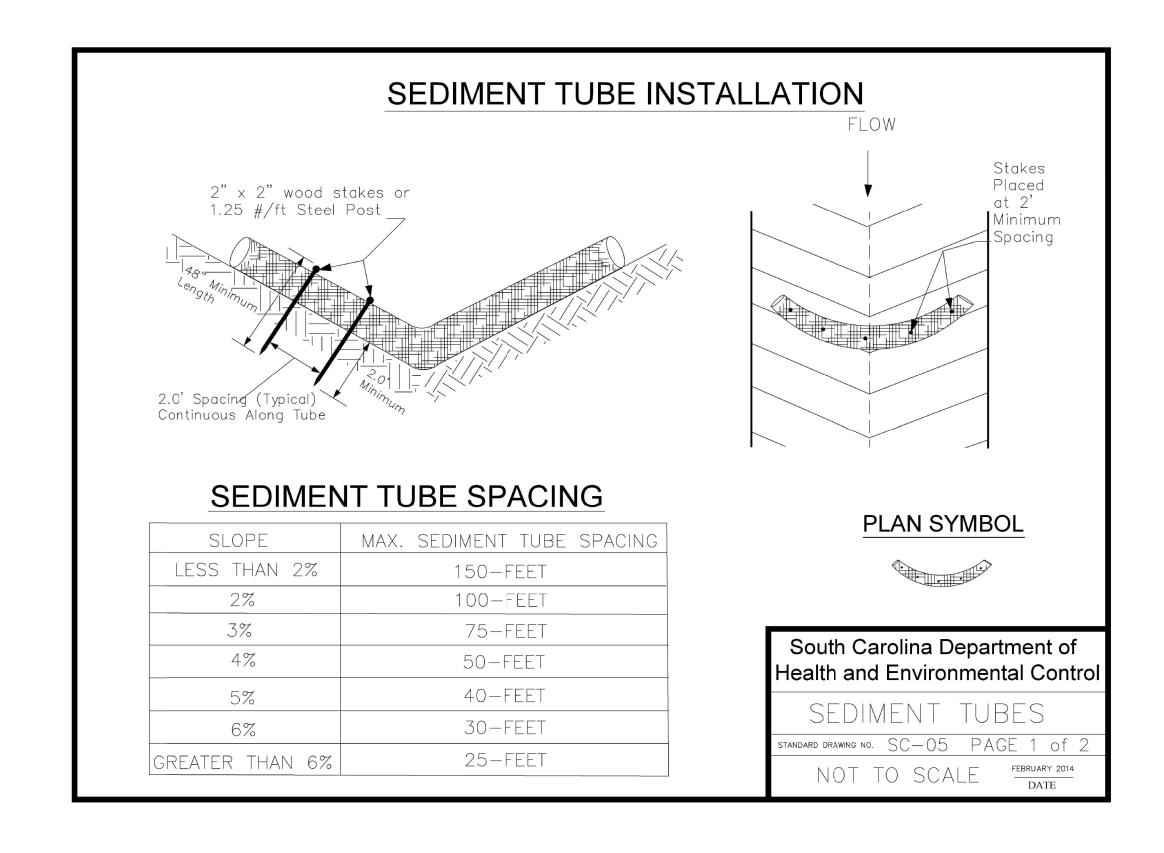


EROSION AND SEDIMENTATION CONTROL DETAILS

FED.RD. DIV.NO	STATE	COUNTY	PROJECT ID	ROAD/ROUTE NO.	SHEET NO.
3	S.C. CHESTERFIELD		21-04464-001		EC-3

RICK HENRY ROAD

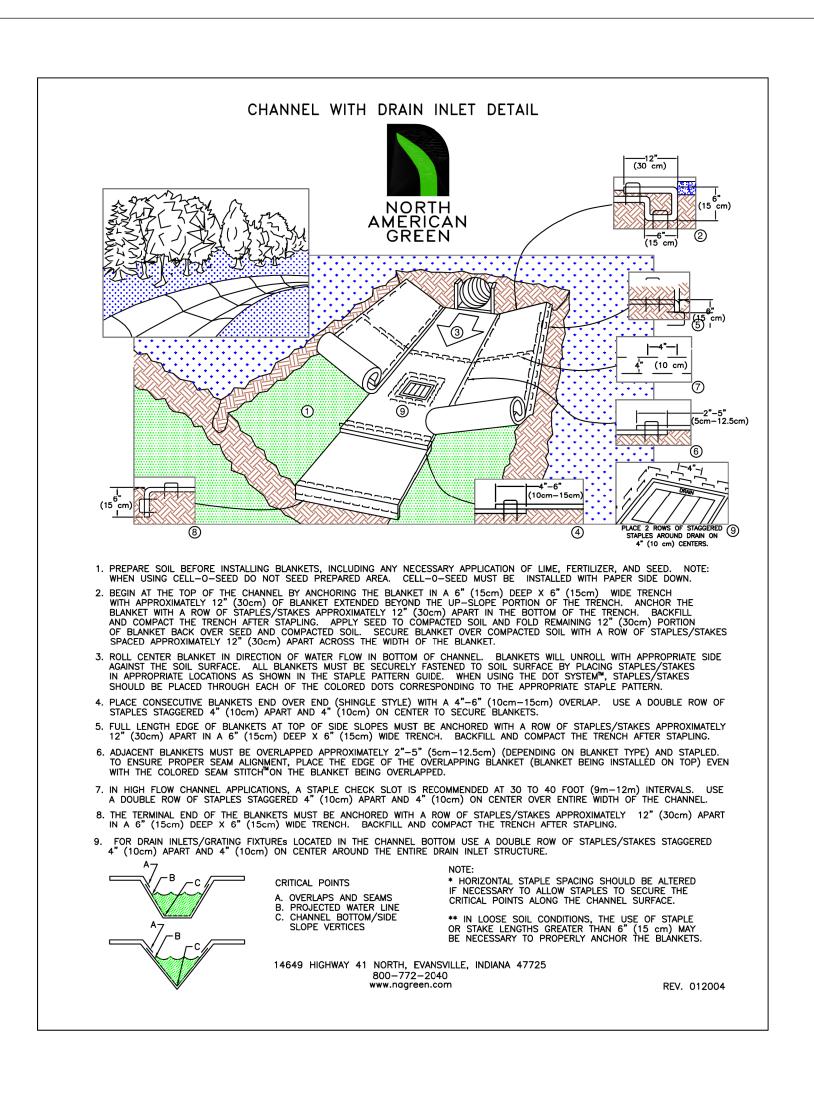

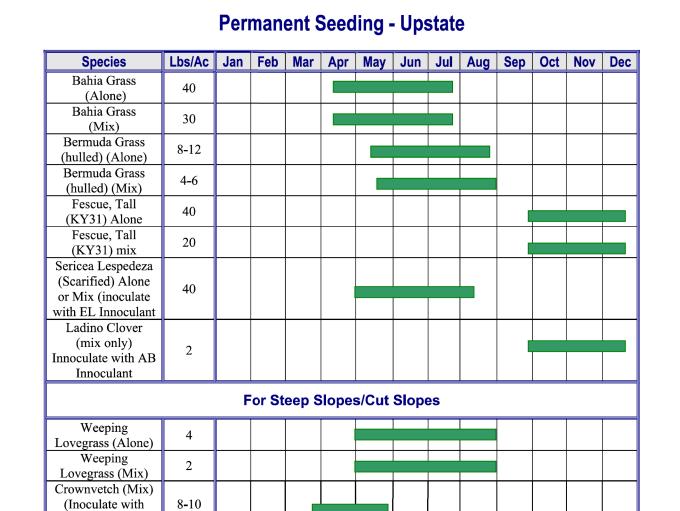


NOTE: PER SC-DHEC PERMANENT SEEDING RATE TABLE FOR UPSTATE, NO PERMANENT SEEDING IS RECOMMENDED BETWEEN MID-DECEMBER AND MID-APRIL.

Temporary Seeding - Upstate

Type M Innoculant

Species	lbs./ac	Jan	Feb	Mar	Apr	May	Jun	Jul	Aug	Sep	Oct	Nov	Dec
Browntop Millet (Alone)	40												
Browntop Millet (Mix)	10												
Rye Grain (Alone)	56												
Rye Grain (Mix)	10												
Rye Grass (Alone)	50												
Rye Grass (Mix)	8												
			For	Stee	p Slo _l	pes/C	ut Slo	pes					
Weeping Lovegrass (Alone)	4												
Weeping Lovegrass (Mix)	2												

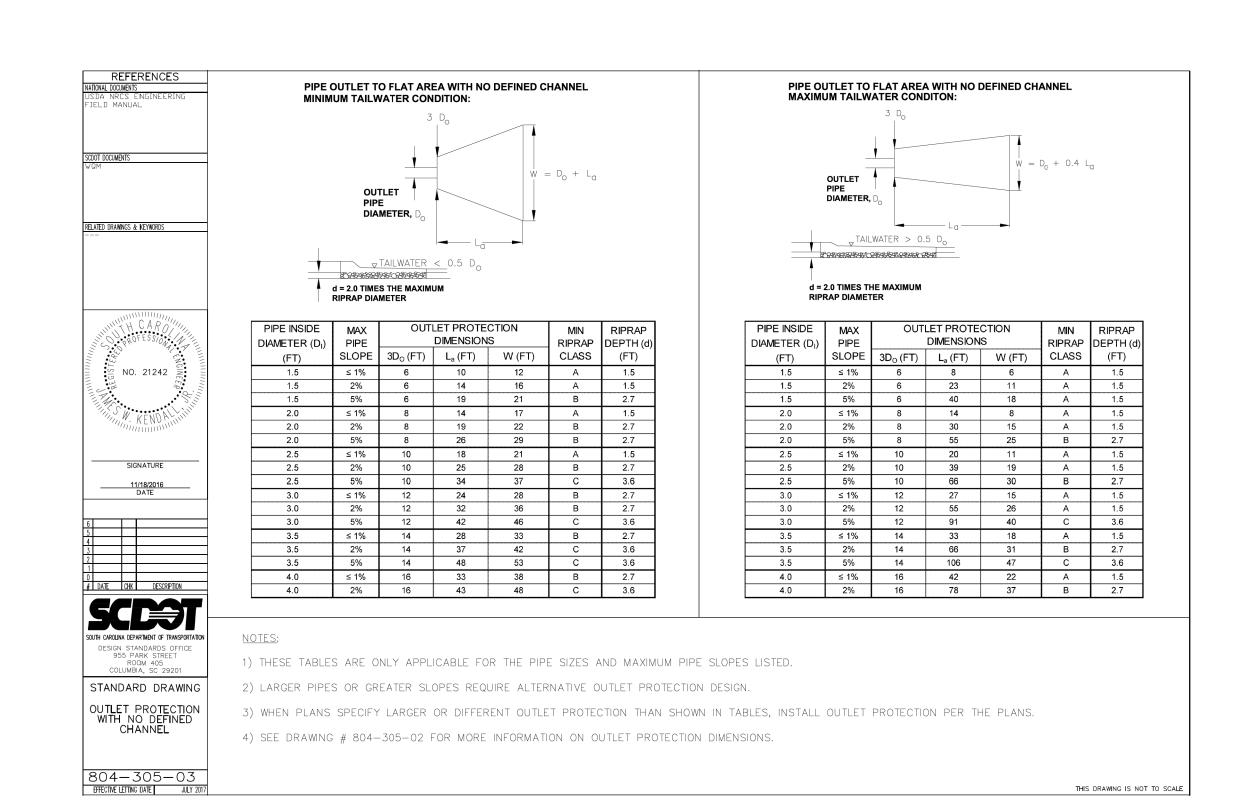

FED. ROAD DIV. NO. STATE COUNTY PROJECT ID PROJECT NO. ROUTE NO. SHEET TOTAL SHEETS

3 S.C. CHESTERFIELD 23-04464-001 ___ EC-4 _ SCDOT R/W AKA W. BOBO NEWSOM HWY SCDOT PROJECT ID # 13.541 PID #122-000-000-060 HCJ INC DEED BOOK 334 PAGE 069 PLAT BOOK 39 PAGE 96 2rc 20°C NPDES = = = = NPDES = = = = NPDES = NP 23°C 25°C 25°C PID #122-000-000-056 NANCY ALDRICH HENRY & JAMES RICHARD HENRY DEED BOOK 345 PAGE 716 PLAT BOOK 18 PAGE 28 CHESTERFIELD COUNTY

uments/Projects/2021/21-04464-001/JMT/Highway and Civil/2D Drawing/Design/EC

CAROLINA DE SONO DE SO

4			
3			
2			
1			
REV. NO.	BY	DATE	DESCRIPTION OF REVISION
TOPO.	DATE		
DWG.	DATE		
R/W	DATE		

EROSION CONTROL SHEET

SCALE 1"= 40' RTE. ___ DWG. NO.

FED. ROAD DIV. NO. STATE COUNTY PROJECT ID PROJECT NO. ROUTE SHEET TOTAL NO. SHEETS

3 S.C. CHESTERFIELD 21-04464-001 ___ EC-5 _ 66. COUNTY MAINTAINED RW. RICK. HENRY ROAD PID #122-000-000-0.
CLARA B PETTUS
(LIFE ESTATE) <≥\2rc PID #122-000-000-059 CLARA B PETTUS (LIFE ESTATE) DEED BOOK 507 PAGE 578




R/W

4				
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REV. NO.	BY	DATE	DESCRIPTION OF REVISION	
TOPO.	DATE			
DWG.	DATE			

CHESTERFIELD COUNTY

EROSION-CONT-ROL-SHEET

SCALE 1"= <u>40'</u> RTE. ___ DWG. NO.

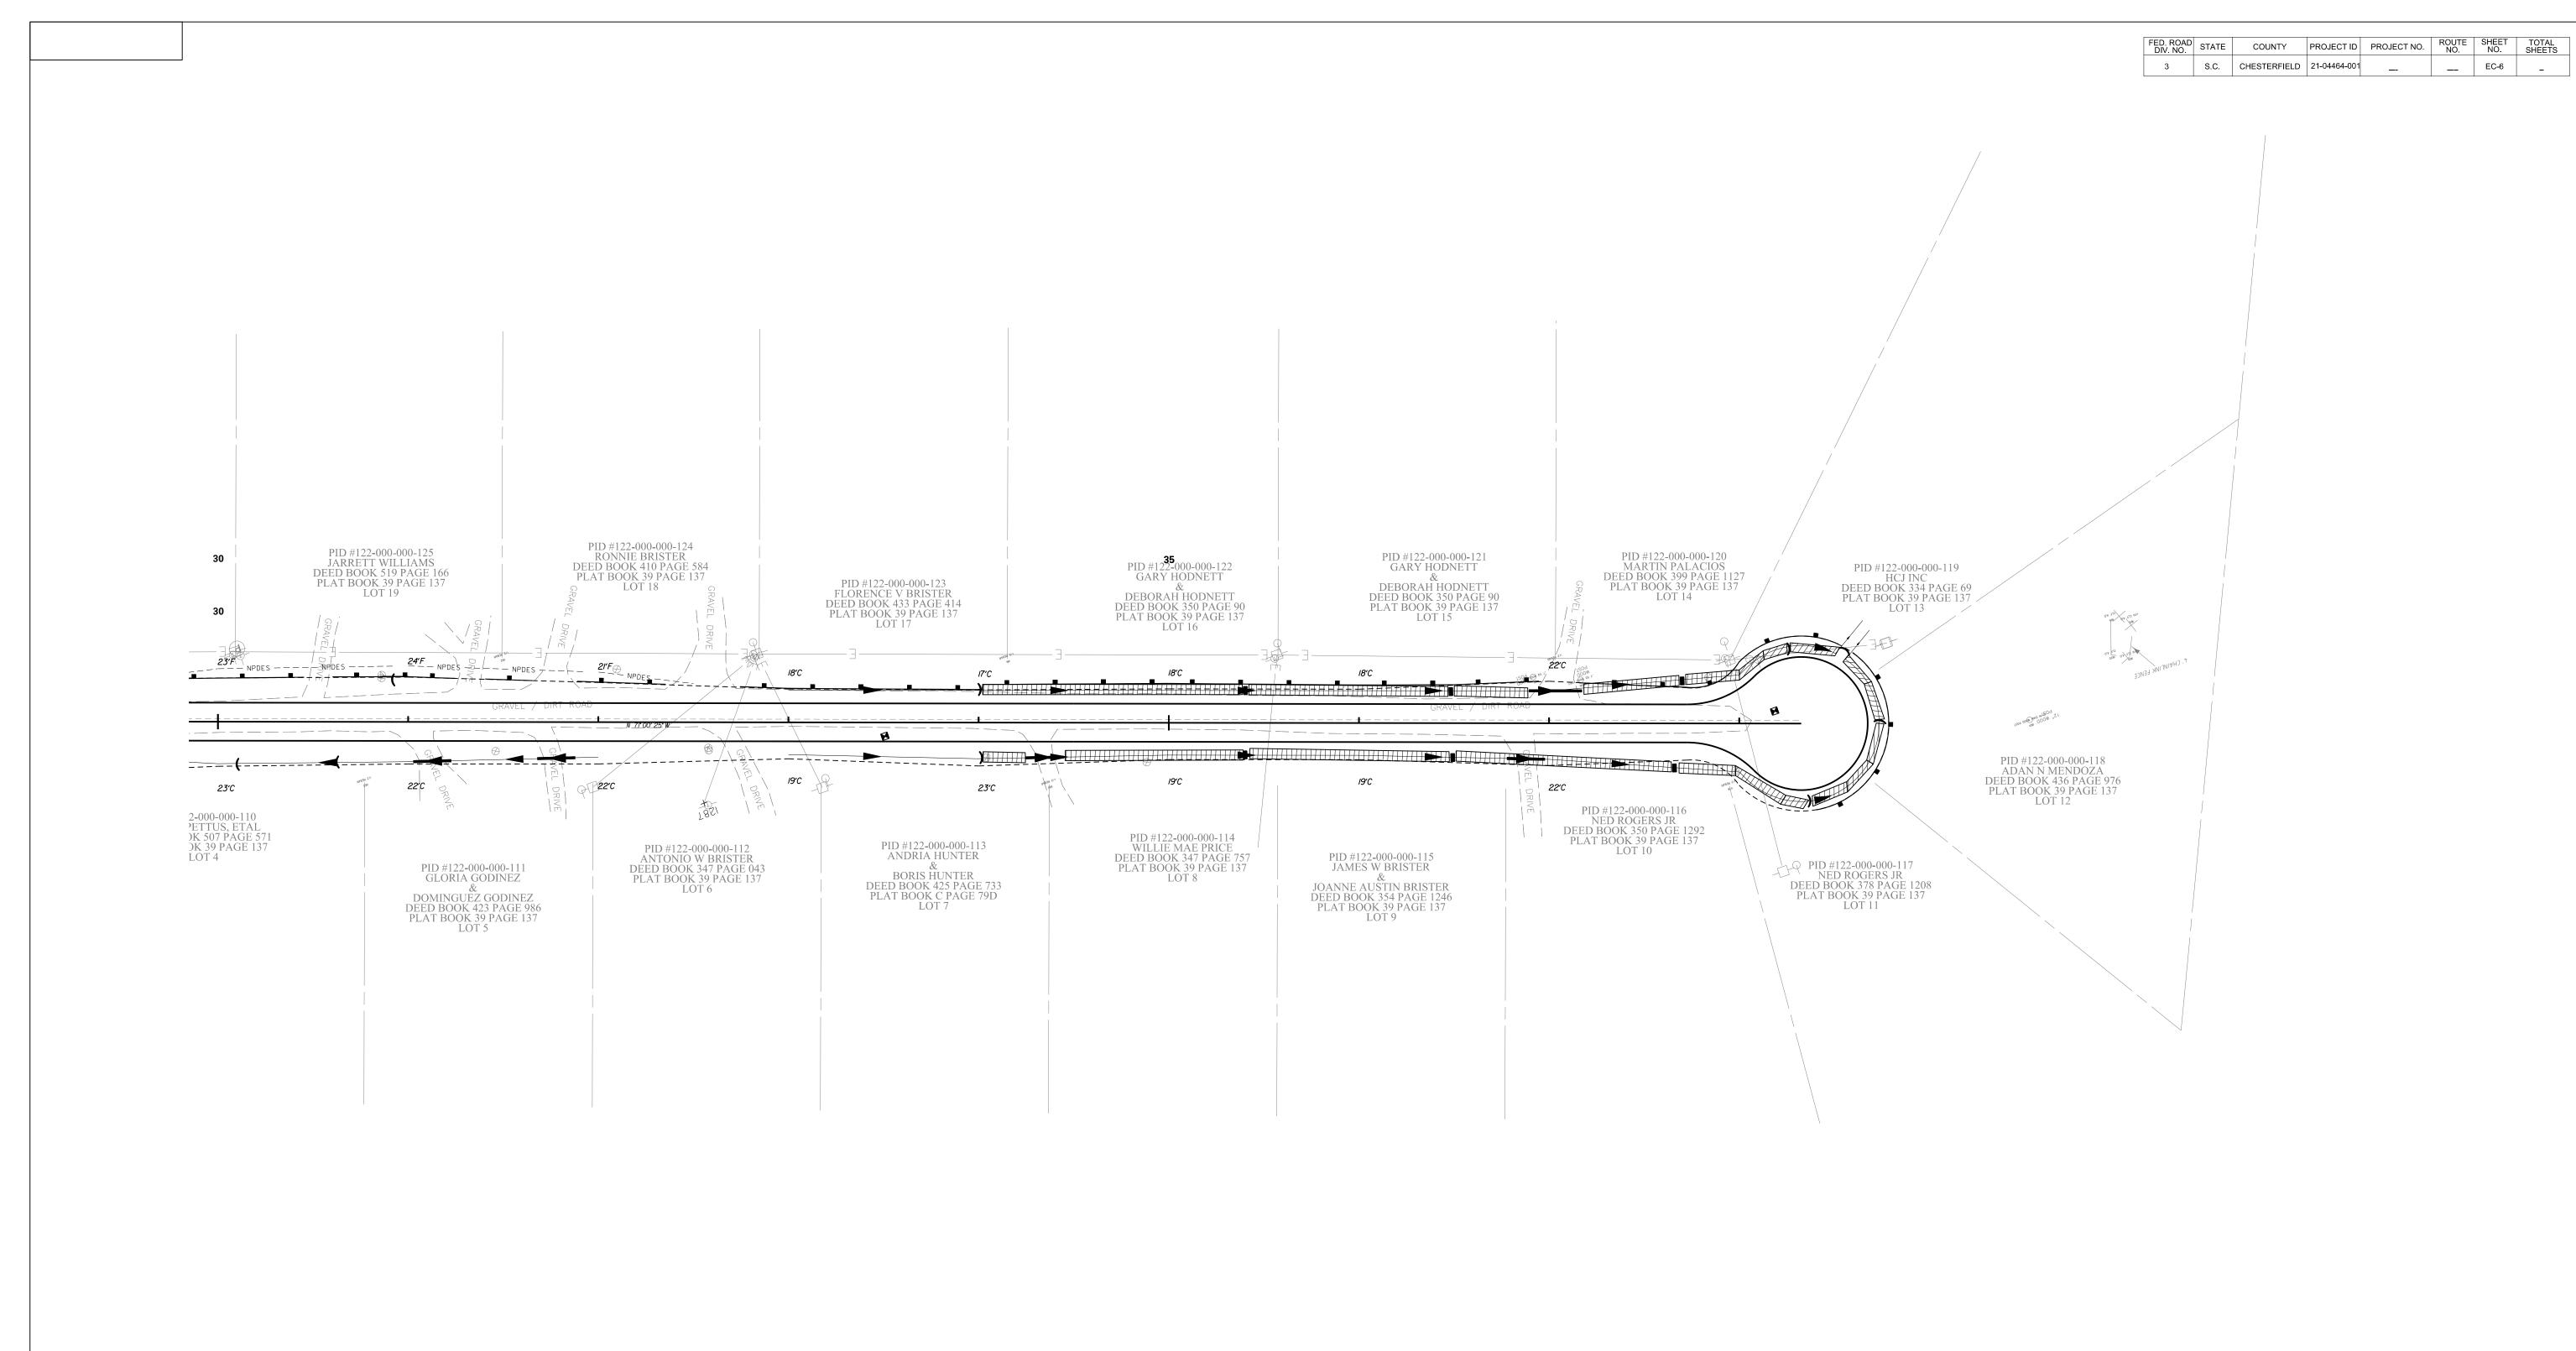



4			
3			
2			
1			
REV. NO.	BY	DATE	DESCRIPTION OF REVISION
TOPO.	DATE		
DMC	DATE		

CHESTERFIELD COUNTY

EROSION CONTROL SHEET

SCALE 1"= <u>40'</u> RTE. ___ DWG. NO.